52 ALFRED STREET, MILSONS POINT FEBRUARY 2023



52 ALFRED STREET, MILSONS POINT

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#### 52 ALFRED STREET, MILSONS POINT

#### **1.1 PROJECT TEAM**

Landowner	
Architect	
Town Planner	
Landscape Architect	
Traffic Engineer	
Heritage Consultant	

Milsons Point 2 Pty Ltd Koichi Takada Architects Ethos Urban Arcadia Barker Ryan Stewart Weir Phillips Heritage

#### **1.2 INTRODUCTION**

This Planning Proposal has been prepared on behalf of Milsons Point 2 Pty Ltd for the site at 52 Alfred Street, Milsons Point. The purpose of this report is to provide supporting information to facilitate assessment of proposed changes to the planning controls for 52 Alfred St, Milson's Point.

This report summarises initial design investigations undertaken for the future development of 52 Alfred St, Milson's Point. Urban and architectural investigations have been undertaken with consideration to a variety of documents including A Metropolis of Three Cities - The Greater Sydney Region Plan, North Sydney LEP and DCP 2013, the NSW Apartments Design Guide and recent approvals in the immediate vicinity of the subject site. The investigation aims to explore appropriate distribution of land uses, massing, building forms, context analysis and an overall building height and floor space ratio for the site for exploration and discussion with Council and the NSW Department of Planning and Environment.

The design provides a new active retail precinct fronting a landscaped through site link, joining Alfred Street to Glen Street and improving pedestrian and neighbouring connectivity through multiple ground floor through site links for a future vision connecting the east to west of the site and improvements to pedestrian permeability north to south.

#### **1.3 DEVELOPMENT SUMMARY**

TOTAL FLOOR SPACE
Site Area
Total GFA
Total Residential GFA
Total Retail GFA
Total Commercial GFA
Total Amenities GFA
FSR

BUILDING HEIGHT

#### UNIT MIX

Total number of Units Studio 1 bedroom 2 bedroom 3 bedroom 4 bedroom

#### LANDSCAPING

Communal Open Space

#### ADG COMPLIANCE

Cross Ventilation Solar (2hr)

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#### PROPOSED

2,711.0m<sup>2</sup> 17,944m<sup>2</sup> 14,188m<sup>2</sup> 867m<sup>2</sup> 2388m<sup>2</sup> 500m<sup>2</sup> 6.62:1

54.48m (BUILDING A) (RL83.75m) 69.17m (BUILDING B) (RL87.10m) From Alfred Street

> 125 Units 0 (0%) 34 (27%) 50 (40%) 35 (28%) 6 (5%)

TOTAL - 834<sup>2</sup> (31%) Ground - 834m<sup>2</sup>

> 62% (43 / 69) 72% (90 / 125)

2.0 SITE ANALYSIS

#### 2.0 URBAN CONTEXT & SITE ANALYSIS

#### SITE DESCRIPTION

The site, located at 52 Alfred St, is located centrally in Milson's Point within the North Sydney Council LGA in a prominent location on the Lower North Shore. The site is positioned approximately 80m to the south-west of the Milson's Point railway station and is highly visible on approach from both the North and South, particularly along the Bradfield Highway and Cahill Expressway.

The subject site is bounded by Alfred St on the east and Glen St on the west. Bradfield Park, a locally significant green open space, is located diagonally opposite the subject site on Alfred St. Development to the immediate north of the site comprises a mixture of commercial and residential, typically 15-20 storeys in height. To the south-east of the site, 48-50 Alfred St is occupied by a 2-storey commercial building and Camden House, a 2-storey heritage-listed building. 3 residential towers of approximately 20-25 storeys are located to the west and further south. Development to the immediate west of the site on the other side of Glen St is comprised predominantly of small scale commercial buildings of less than 10 storeys in height.

The site falls gently from north to south along Alfred St, and sits in a shallow depression along the Glen St frontage on its western boundary. There is a significant difference in level between Alfred St and Glen St, currently serviced by way of a publicly accessible stair on Glen St that connects to the throughsite linkage along the southern boundary of the site.

The site is a 12 storey commercial building with 4 storeys of below ground car parking. Vehicular access to the site is provided from two access points: Glen St and Alfred St (through a private shareway to the podium level). The basement (Glen St frontage) and ground level (Alfred St) currently accommodate a total of 2 retail tenancies.

#### **BUILT FORM**

The design investigations for 52 Alfred St explore the benefits of increasing the height and residential density in Milson's Point. With access to a wide variety of transportation options, the development of the subject site has the potential to act as a catalyst for future growth in the area. The proposed design aims to revitalise and activate the streetscape by redesigning the through-site connection to Glen St, providing a sheltered and landscaped urban space, introducing a mixture of new retail and food and beverage tenancies. An additional ground floor through site link for a future vision connecting the north to south side of the site promoting high level of permeability on the ground floor. Ultimately, the intention is to provide a benchmark development that provides a significant contribution to the public domain and future character of Milson's Point.

#### **OBJECTIVES**

#### **PUBLIC BENEFIT**

The central location of the subject site at the heart of Milson's Point provides the opportunity to contribute to the future development and character of the area. The public domain strategy of the development is to retain and enhance the existing underutilised east-west through-site link via the introduction of a mixture of new retail and food and beverage tenancies and a variety of urban and landscaped spaces. An additional proposed ground floor through site link for a future vision connecting the north to south side of the site also promotes high level of permeability to the ground floor. In positioning the north south connection along the axis of Camden House, a strong focal point and visual connection to the hertiage item enhances it's significance.

Through the provision of these pedestrian connections, the site has the potential to become a new centre of activity on the western side of Milson's Point railway station. The improved public domain will also serve to generate pedestrian interest and traffic through to Glen St, paving the way for future development and increased residential density in this area. There is to be no vehicular access to the site via Alfred St, thus improving pedestrian amenity and acting as a pedestrian priority zone by reducing the volume of traffic entering the current existing shared access driveway along the southern boundary.

#### CONTEXT

The design investigations indicate that in order to protect the amenity of neighbouring buildings and public open space, the site would benefit from additional height allowance above the 40m LEP height limit. The built form would still be perceived as being of a consistent size and scale with adjacent buildings. The provision of generous public domain enhancements and introduction of new public open space has the potential to enliven and activate the mostly dormant streetscape in the area.

#### **BUILT FORM STRATEGY**

Additional height allowances above the 40m LEP height limit are proposed for the site given that many of the surrounding existing and future developments exceed this limit. Accordingly, the subject site should be afforded the same consideration in order to maintain a consistent street character and perceptible height to the surroundings.

The built form of the building and articulation of the facade is designed to reduce its visible bulk and allow it to be perceived as fine-grained in scale. The building form creates a strong delineation between podium and tower, aligning to the adjacent podium to 68 Alfred Street. The top of the tower steps down towards Alfred St to present a perceptible building height consistent with that of the adjacent building, minimising the adverse impact on the amenity of neighbouring buildings and zero overshadowing over Bradfield Park. At the rear of the site, the tower presents a setback between of 3 - 10.58 m to Glen St.


52 ALFRED STREET MILSONS POINT



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2.1 AERIAL VIEW - LOCATION PLAN

2.2 AERIAL VIEW - CONTEXT PLAN

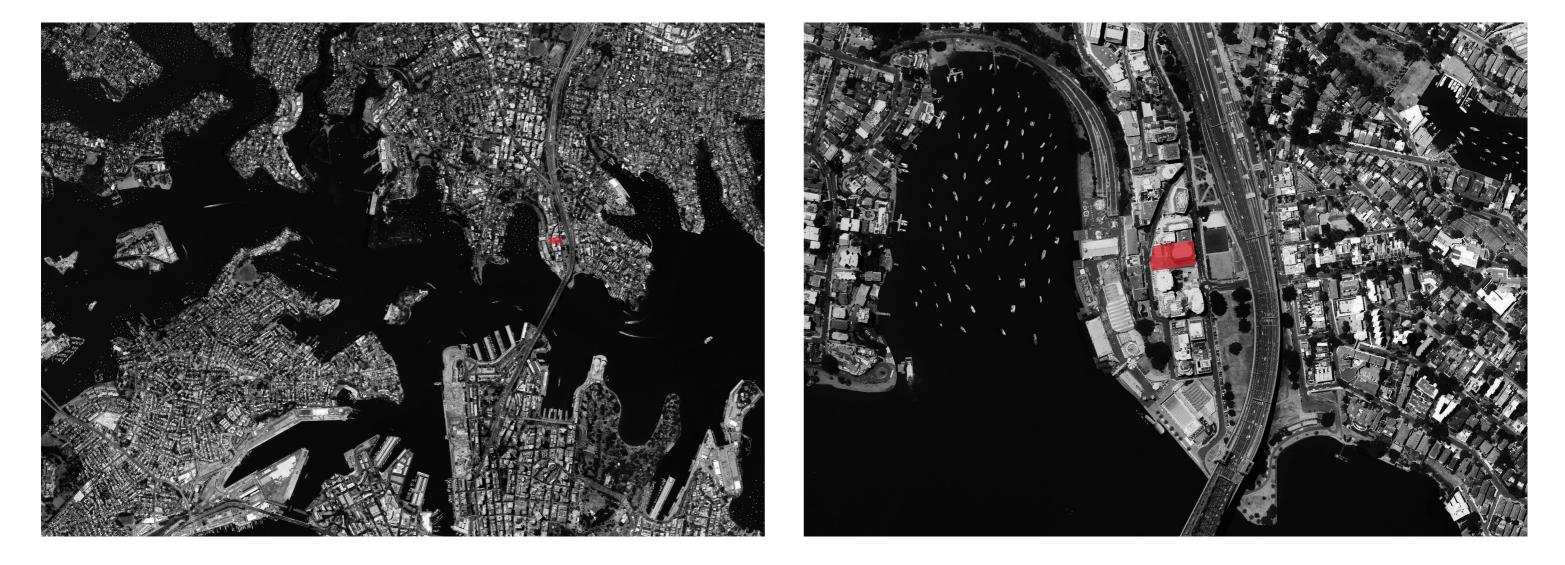

SITE LOCATION

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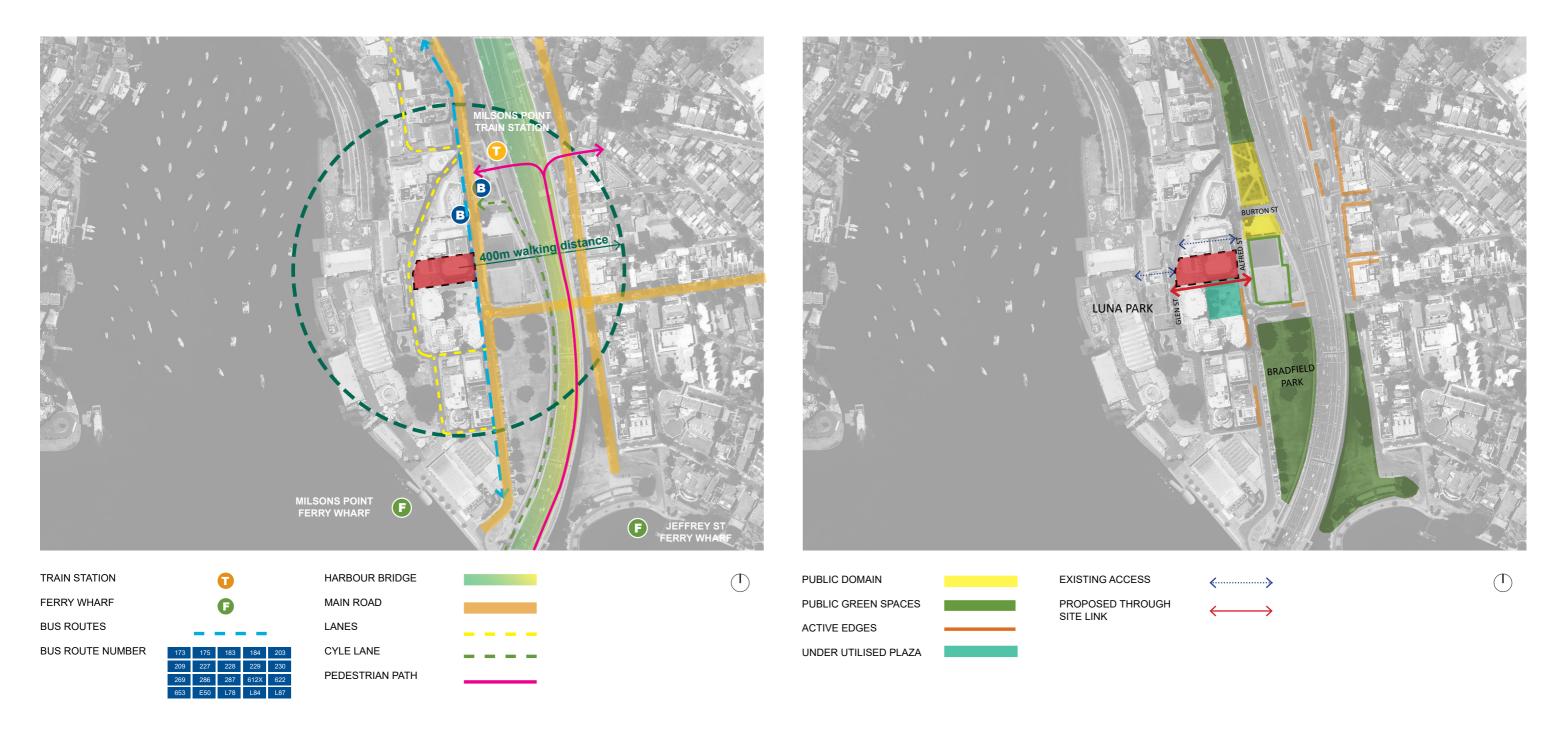
#### 52 ALFRED STREET, MILSONS POINT

#### 2.3 SITE ANALYSIS - TRANSPORT ACCESS

Numerous modes of public transport are located within 400m walking distance from the site including Milsons Point Railway Station and the buses along Alfred Street. The direct access to major transport links and pedestrian connections creates many opportunities for the site.

#### 2.4 SITE ANALYSIS - PUBLIC DOMAIN

The subject site is served by a multitude of public green spaces and community facilities. The introduction of new retail and dining tenancies and a variety of landscaped spaces along the proposed through site link would activate the under utilised plaza next to the site hence generating pedestrian interest and traffic through to Glen St.



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#### 2.5 HEIGHT ANALYSIS - SURROUNDING DEVELOPMENTS

The building height of 54.43m (RL 87.10 - 18 storeys) proposed to the Glen St frontage is of similar scale to the majority of the residential towers along Glen St, including 70 Alfred Street (RL96.20), 37 Glen St (RL87.40) and 48 Alfred Street (RL 100.20).



(T)

The tower form will be set back from the podium in order to reduce the bulk and scale of the building and minimise adverse impact on the views and amenity of residents of 37 Glen St.

A1 52 Alfred St **BUILDINGS EXCEEDING 26m** LEP HEIGHT LIMIT 30 Glen St C1 **BUILDINGS EXCEEDING 40m** LEP HEIGHT LIMIT C2 80 Alfred St C3 70 Alfred St C4 37 Glen St C5 48 Alfred St **C6** 2 Dind St C7 38 Alfred St **C8** 88 Alfred St

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RL (m)	EXCEEDANCE HEIGHT (m)
87.10 (Proposed)	14.4
86.3	26.9
91.5	21.1
96.2	26.4
87.4	18.1
100.2	31.9
95.6	30.5
91.7	27.1
88.6	14



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2.6 SITE PHOTOGRAPHS



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2.6 SITE PHOTOGRAPHS



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2.7 VIEW ANALYSIS



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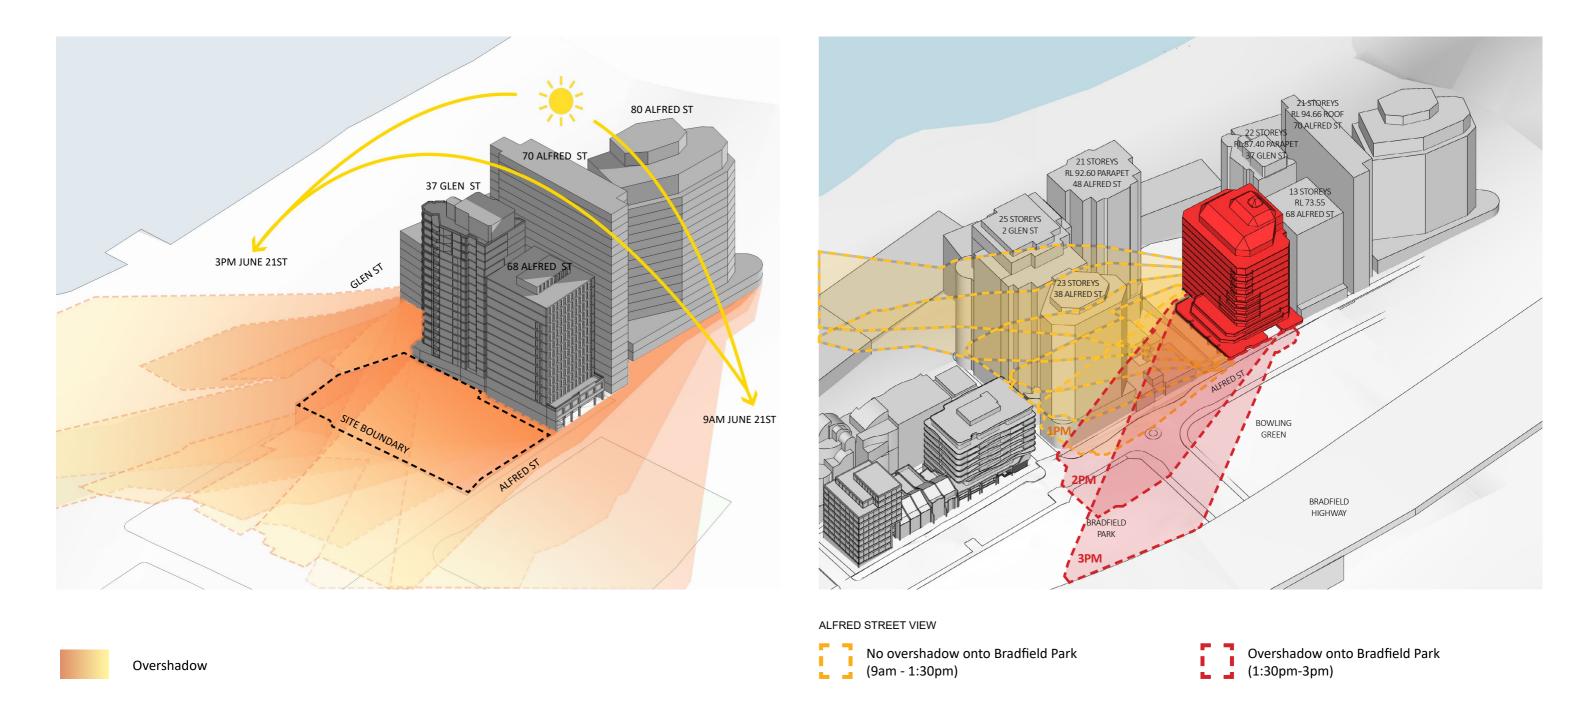
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#### 2.8 SOLAR ANALYSIS

#### 2.9 EXISTING OVERSHADOWING BRADFIELD PARK

The immediate surrounding cluster of tall buildings overshadows the site from 9am to 3pm during mid-winter and lends the proposal to an east

west orientation due in order to maximise on direct solar access.




52 ALFRED STREET MILSONS POINT

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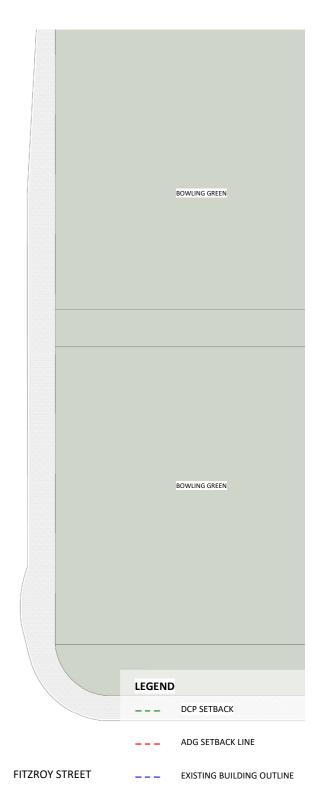


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#### 2.10 SITE SETBACKS



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## 3.0 COMPARISON BETWEEN EXISTING BUILDING AND PLANNING PROPOSAL 06
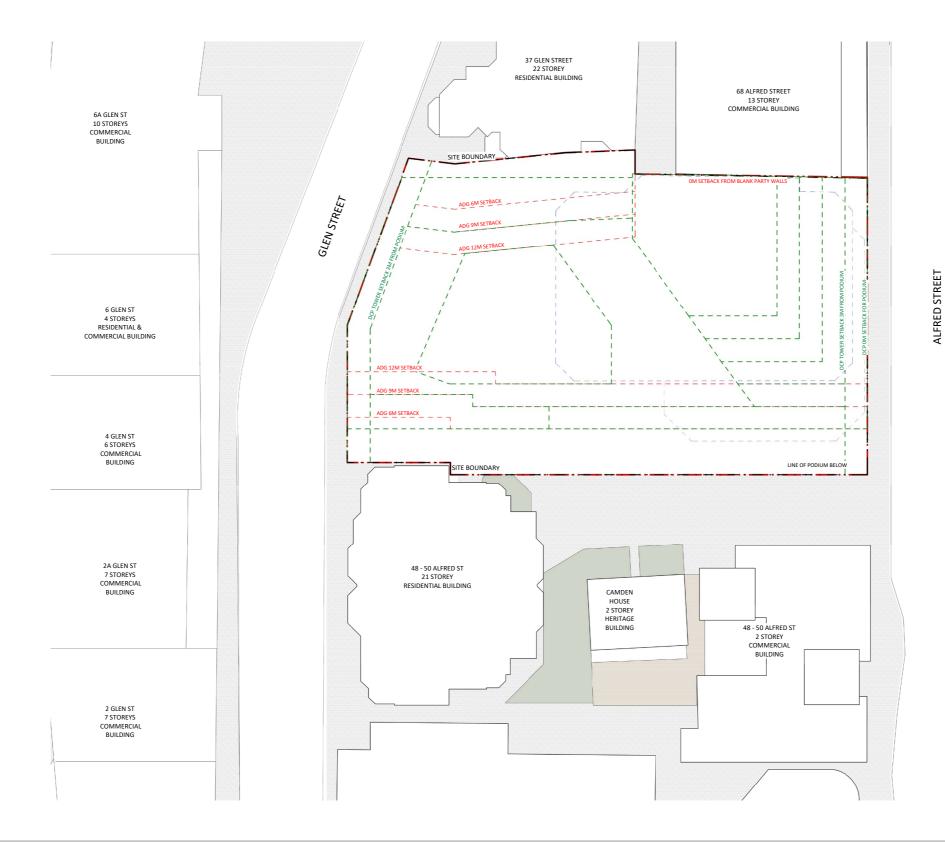
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#### 3.1 ALFRED STREET PROPOSED BUILDING HEIGHTS

EXISTING




PROPOSED




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#### 3.1 PROPOSED BUILDING HEIGHTS



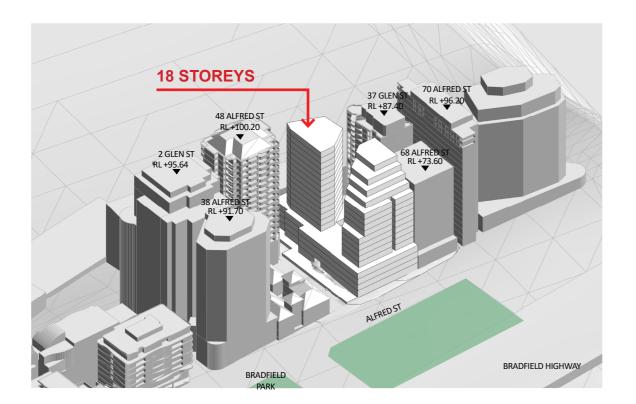

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3.2 VIEW SHARING WITH NEIGHBOURING GLEN ST

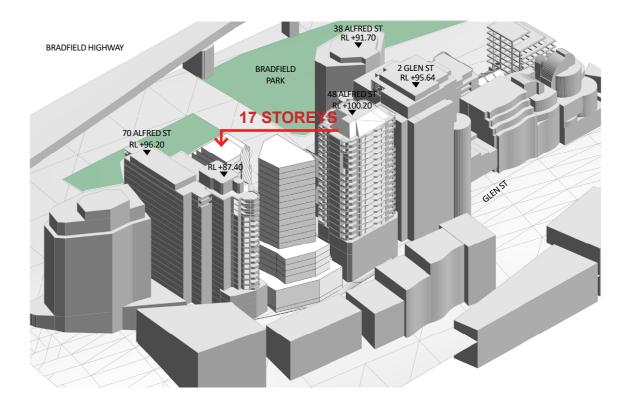

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4.0 DESIGN PRINCIPLES

#### **4.1 DESIGN PRINCIPLES**

The design process took into account detailed overshadowing impacts, view impacts and height and setback constraints to provide a proposed building that

minimises any negative environmental impact but also enhances the public domain.

#### **DESIGN DESCRIPTION**

The proposed development is a mixed use tower in the heart of Milson's Point which includes an enhanced through-site link and new ground level public plaza. In summary, the proposed development is comprised of the following:

- New 18 storey residential tower (22 storeys including 4 basement levels fronting Glen Street)
- · Provision of a publicly accessible civic square at ground level on Alfred St;
- · Improved through- site link between Alfred Street and Glen Street
- Additional ground floor through site link for a future vision connecting the north to south side of the site.
- · Improvements to site activation
- · High level of permeability of ground floor.
- · Provision of several new food and beverage and small retail outlets
- · Provision of approximately 3255m<sup>2</sup> of new commercial and retail space.
- Further setback to the Glen Street frontage to allow for view sharing to neighbouring 37 Glen street. • Further shadow studies were conducted and it was discovered that balconies to 38 Alfred Street already had cast shadow to Bradfield Park. Further massing analysis conducted to unify the building through merging the slot proposed in the previous planning proposal submission. No additional overshadowing to Bradfield Park is proposed.


The development comprises of a 2 storey high podium with 2 tower components at differing heights. The proposed height of the podium on the Alfred St frontage adheres to the typical 2 storey podium heights of the surrounding developments in order to preserve a visually unified street frontage. Each proposed tower component built forms relate to the two differing scales of the existing Glen and Alfred Street frontages.

Fronting Alfred Street, the building form is 17 storeys (including the 2 storey podium) but due to the terraced form stepping away from Alfred Street, there is a streetscape perception of 14 storeys and alignment to the adjacent 68 Alfred Street in maintaining a continuous street wall. The built form to Glen Street reaches a maximum height of RL87.10 at 18 storeys (22 storeys including the 4 basement storeys fronting Glen Street). The height is consistent with the neighboring 37 Glen Street (RL87.40) to create a consistent streetscape and is significantly lower than the 48 Alfred Street RL100.20.

The existing pedestrian access through the site to Glen Street is via a series of winding staircases. The proposal seeks to improve this connection with the provision of an active through site link, landscaping to create visual interest and a series of retail tenancies with outdoor seating to promote activation. An additional ground floor through site link for a future vision connecting the north to south side of the site will also provide a high level of permeability on the ground floor. Pedestrian amenity will be improved by removing the existing vehicular basement access to the site via Alfred St and thus reducing the volume of traffic, access would continue to be provided along the western boundary via Glen St

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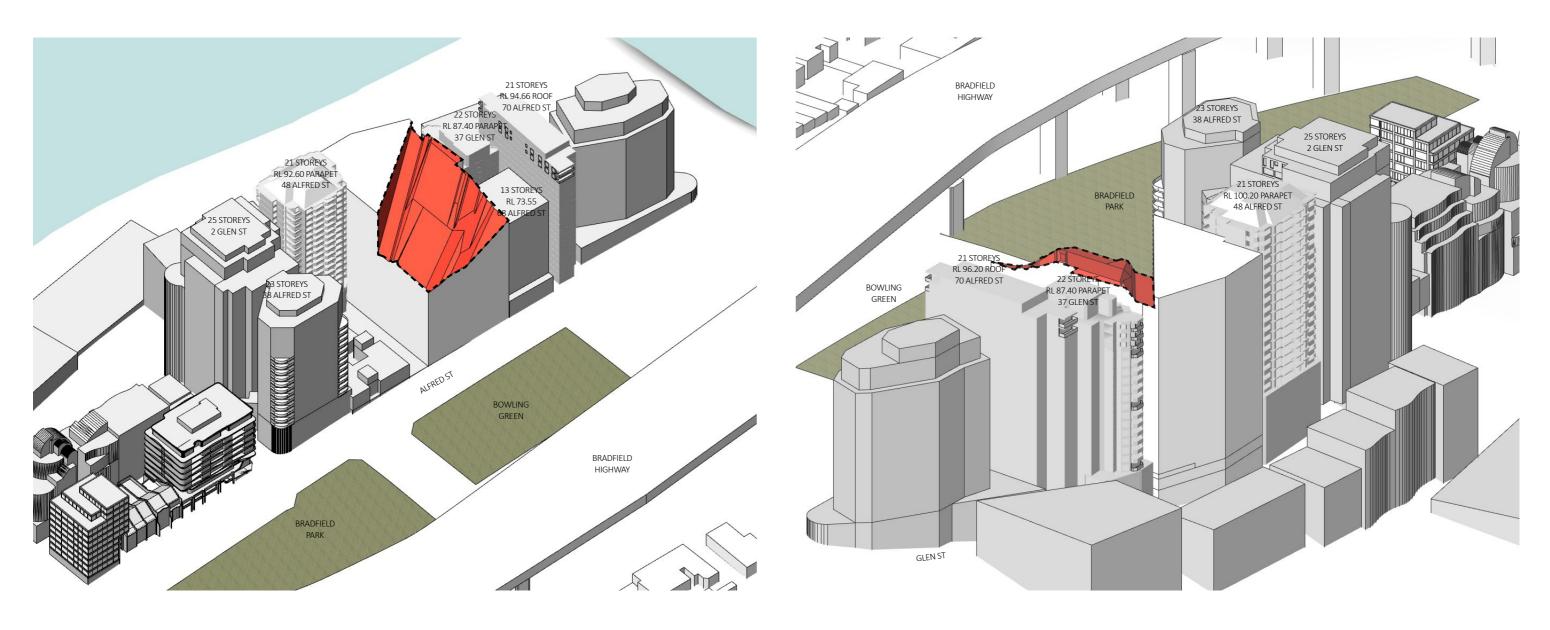
#### 4.2 SOLAR ACCESS TO BRADFIELD PARK

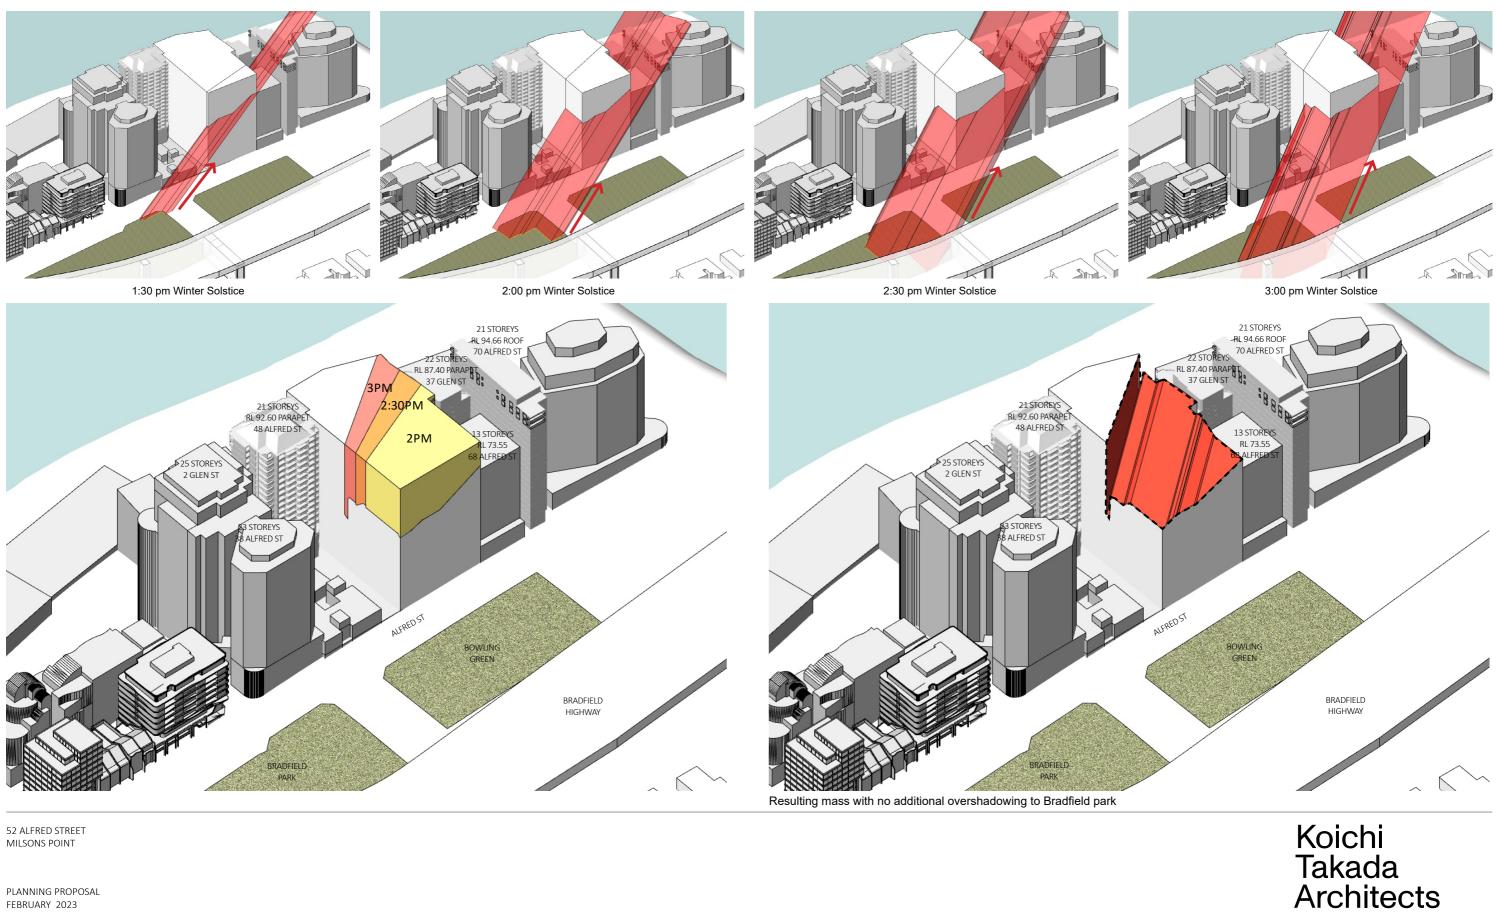

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4.3 NO ADDITIONAL OVERSHADOWING MASS



ALFRED STREET VIEW


GLEN STREET VIEW

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#### 4.4 ADG SETBACKS



ALFRED STREET VIEW


GLEN STREET VIEW
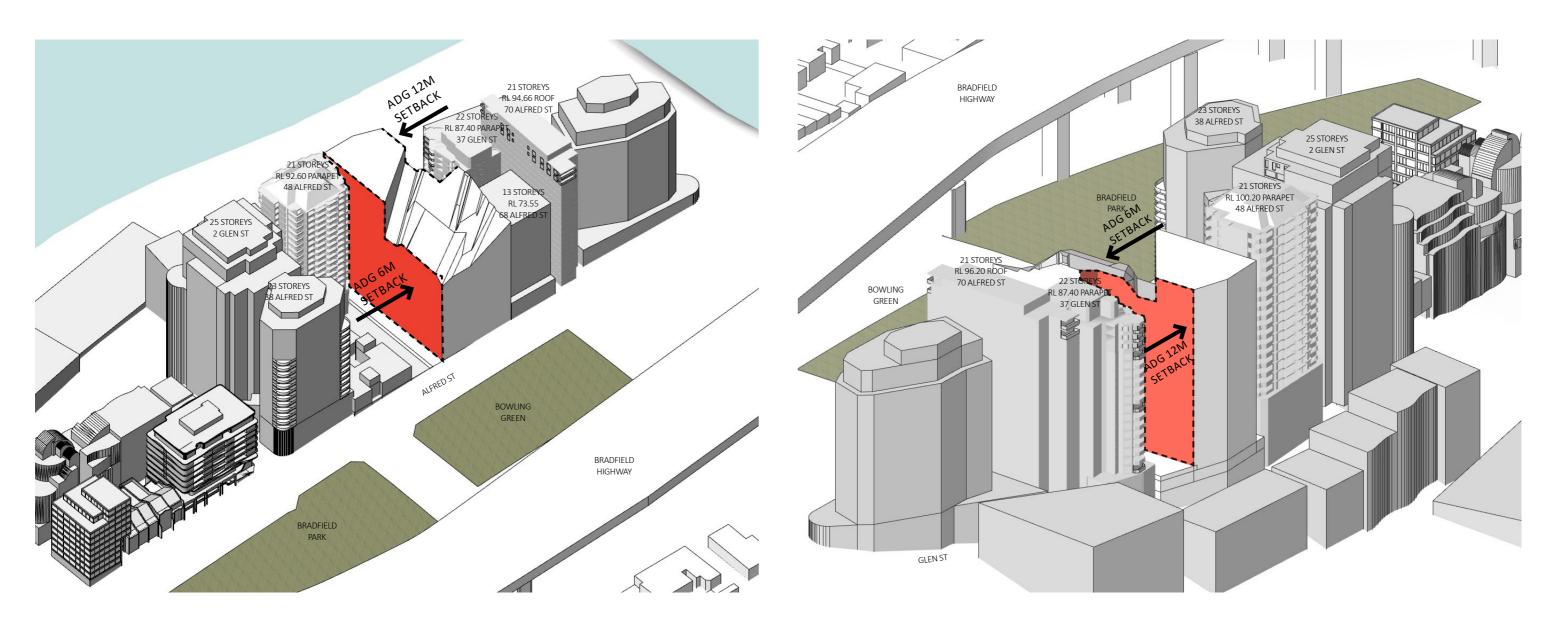
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4.5 SITE-SPECIFIC SECTION 9.1.4 DCP SETBACKS



GLEN STREET VIEW

ALFRED STREET VIEW

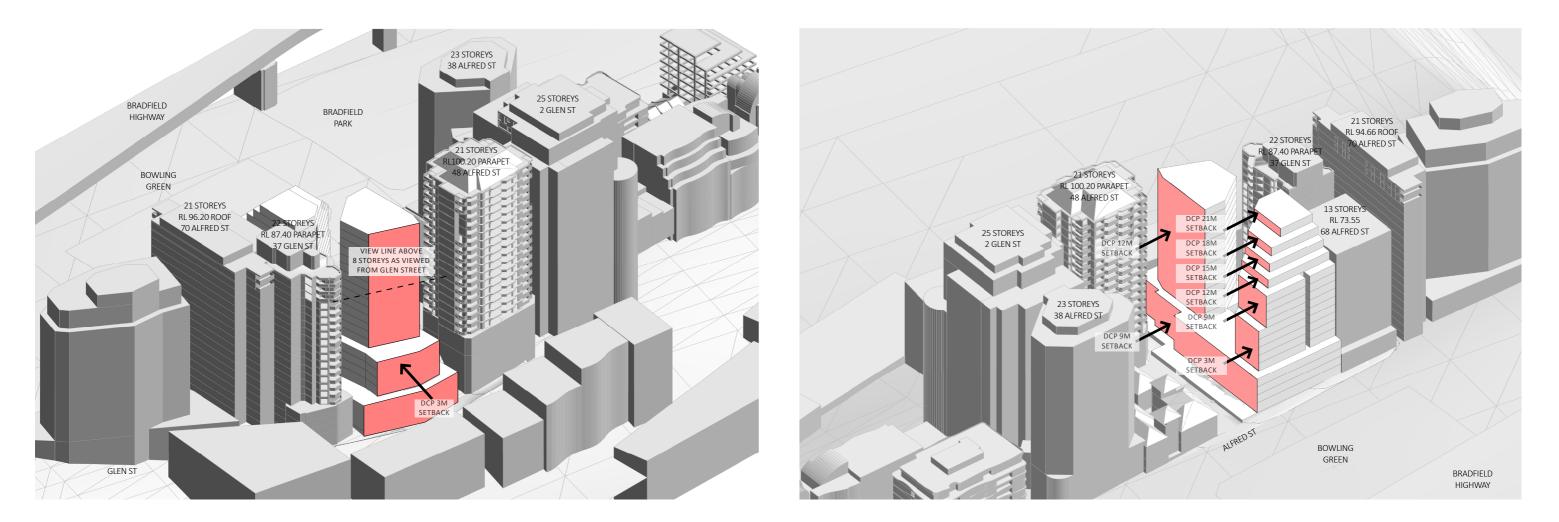
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#### 4.6 SETBACK TO CAMDEN HOUSE



ALFRED STREET VIEW

SECTION

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CAMDEN HOUSE 1987

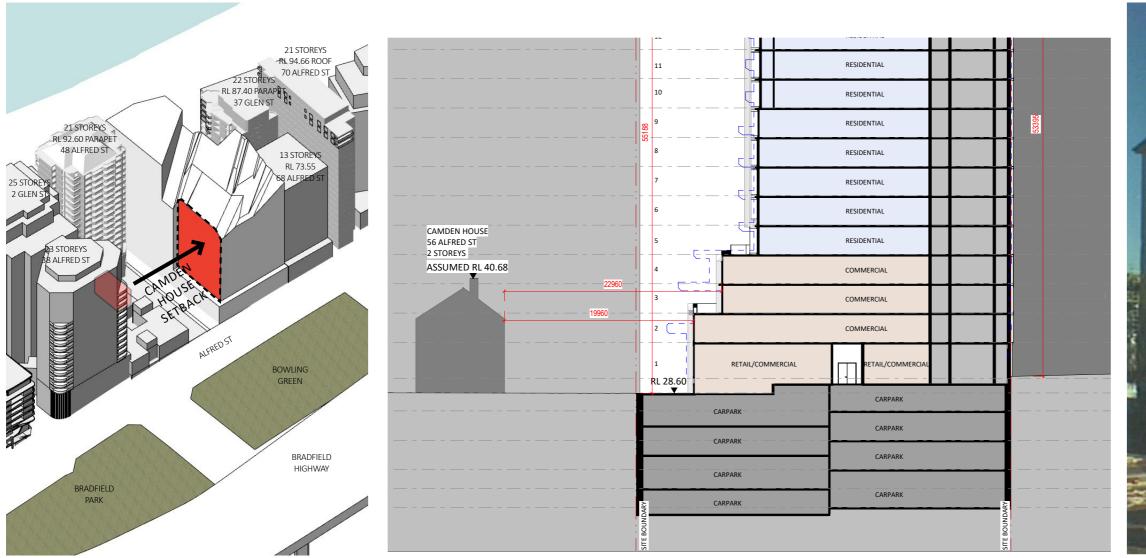


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#### **4.7 CUTTING MASS FOR NEIGHBOURS VIEWS**

A setback ranging from 3 - 10.58 m is proposed to ensure that views from the adjacent residential tower located at 37 Glen St are preserved, resulting in a significant volumetric reduction of the building envelope.

This design gesture provides the further benefit of creating a clearer delineation between the podium and tower built mass, allowing the height of the proposed podium to be in keeping with many of the adjacent buildings along the Glen St frontage.

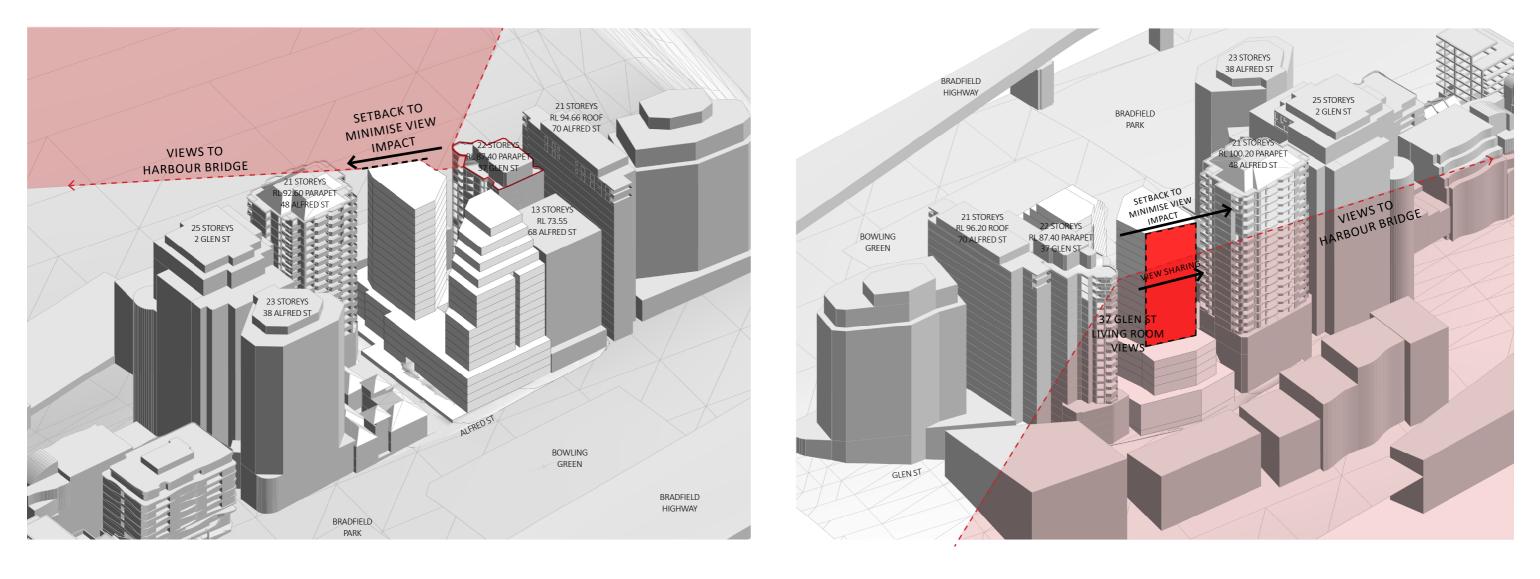

ALFRED STREET VIEW


GLEN STREET VIEW

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#### 4.8 THROUGH SITE LINK

The central location and dual frontage of the site allows for a unique opportunity to increase public amenity and provide a through-site link from Alfred St to Glen St at the rear. The existing underutilised through-site link can be improved by introducing a mixture of new retail and food and beverage tenancies to create a more active frontage.




ALFRED STREET VIEW

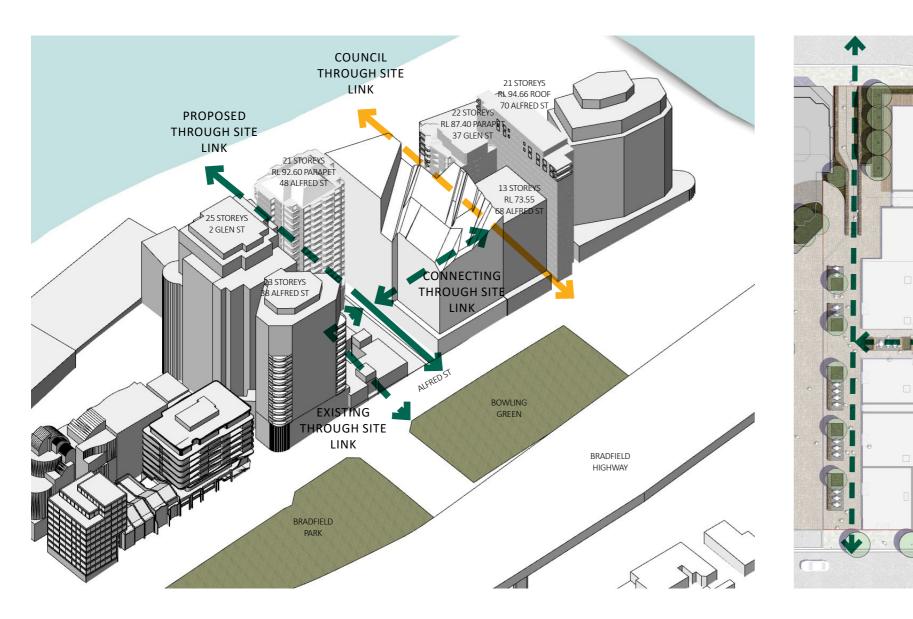PROPOSED THROUGH SITE LINK

A wider through-site link with landscaping and a permeable retail space will allow weather protection and a more pedestrian friendly link to Glen Street.

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#### EXISTING THROUGH SITE LINK

The poorly lit and narrow through site link is uninviting and discourages pedestrian activity.

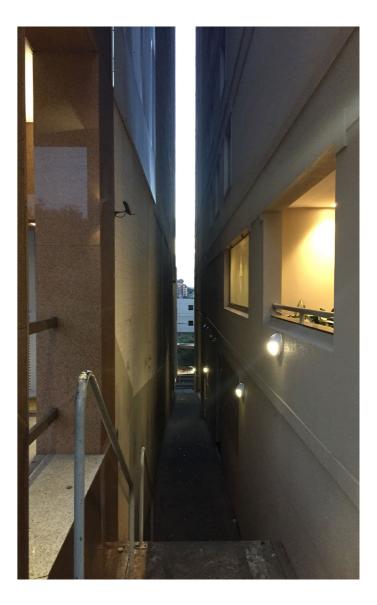

#### 4.9 EXISTING THROUGH SITE LINK



EXISTING SHAREWAY


EXISTING COUNCIL THROUGH SITE LINK BETWEEN 68 AND 70 ALFRED STREET

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4.10 PROPOSED THROUGH SITE LINK - PERSPECTIVE



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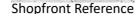
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#### 4.10 THROUGH SITE LINK -PUBLIC BENEFIT, SITE ACTIVATION AND **PRIORITISING THE PEDESTRIAN**

- The proposed enhanced through site link and new ground level public plaza will revitalise and connect Alfred Street and Glen Street into the broader pedestrian network.
- Additional ground floor through site link for a future vision connecting the north to south side of the site.
- Re-establishes the heritage relationship as a focal point of the north and south connection. •
- · Combine open space, retail activation and landscape to create a destination for locals. Provision of several new food and beverage and small retail outlets.
- Provision of approximately 2642m<sup>2</sup> of new commercial and retail space. •

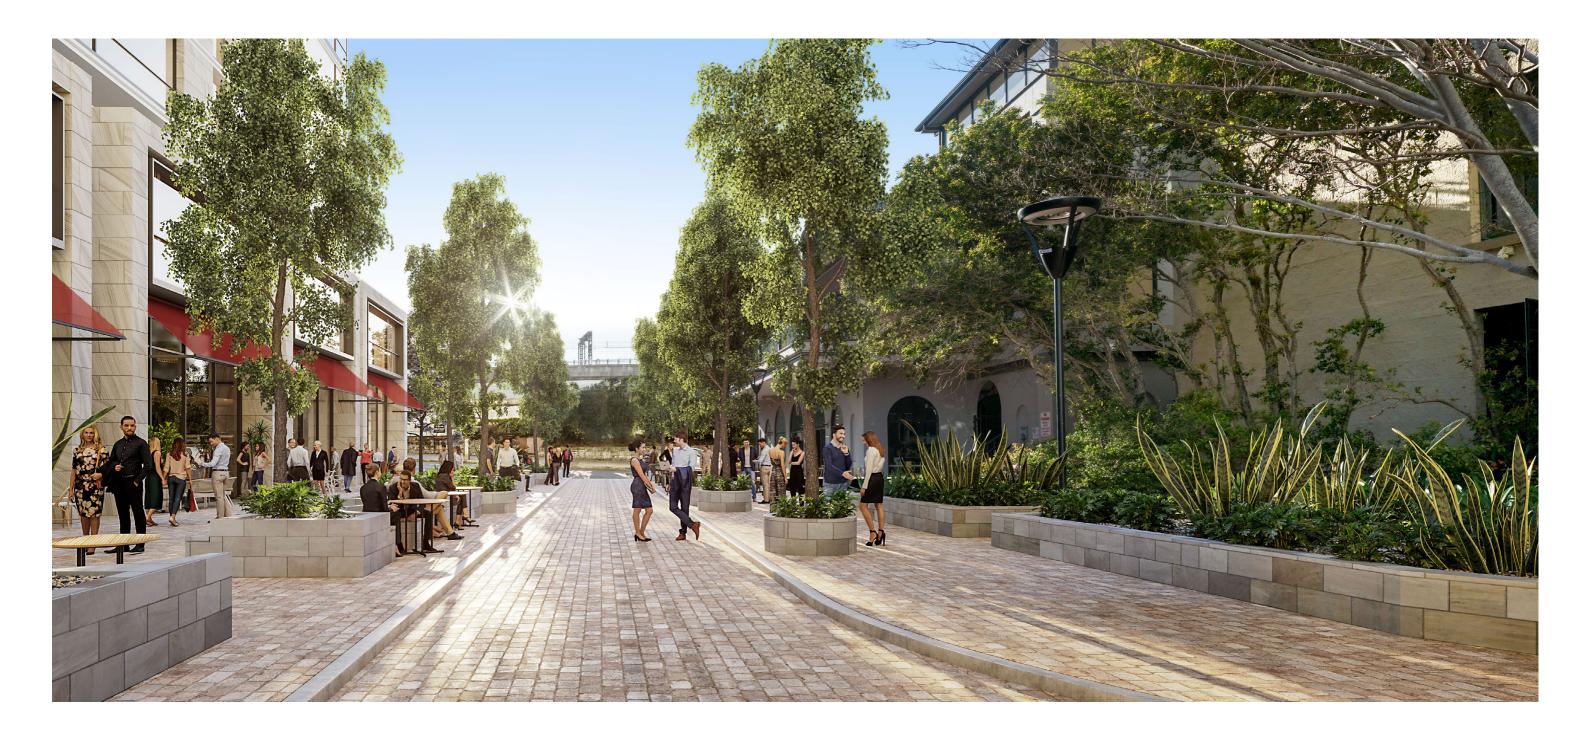










Steam Mill Lane, Sydney

Arc by Crown, Sydney

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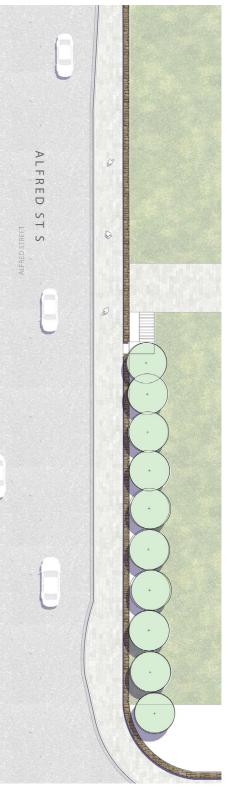


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#### 4.11 LANDSCAPE MASTER PLAN

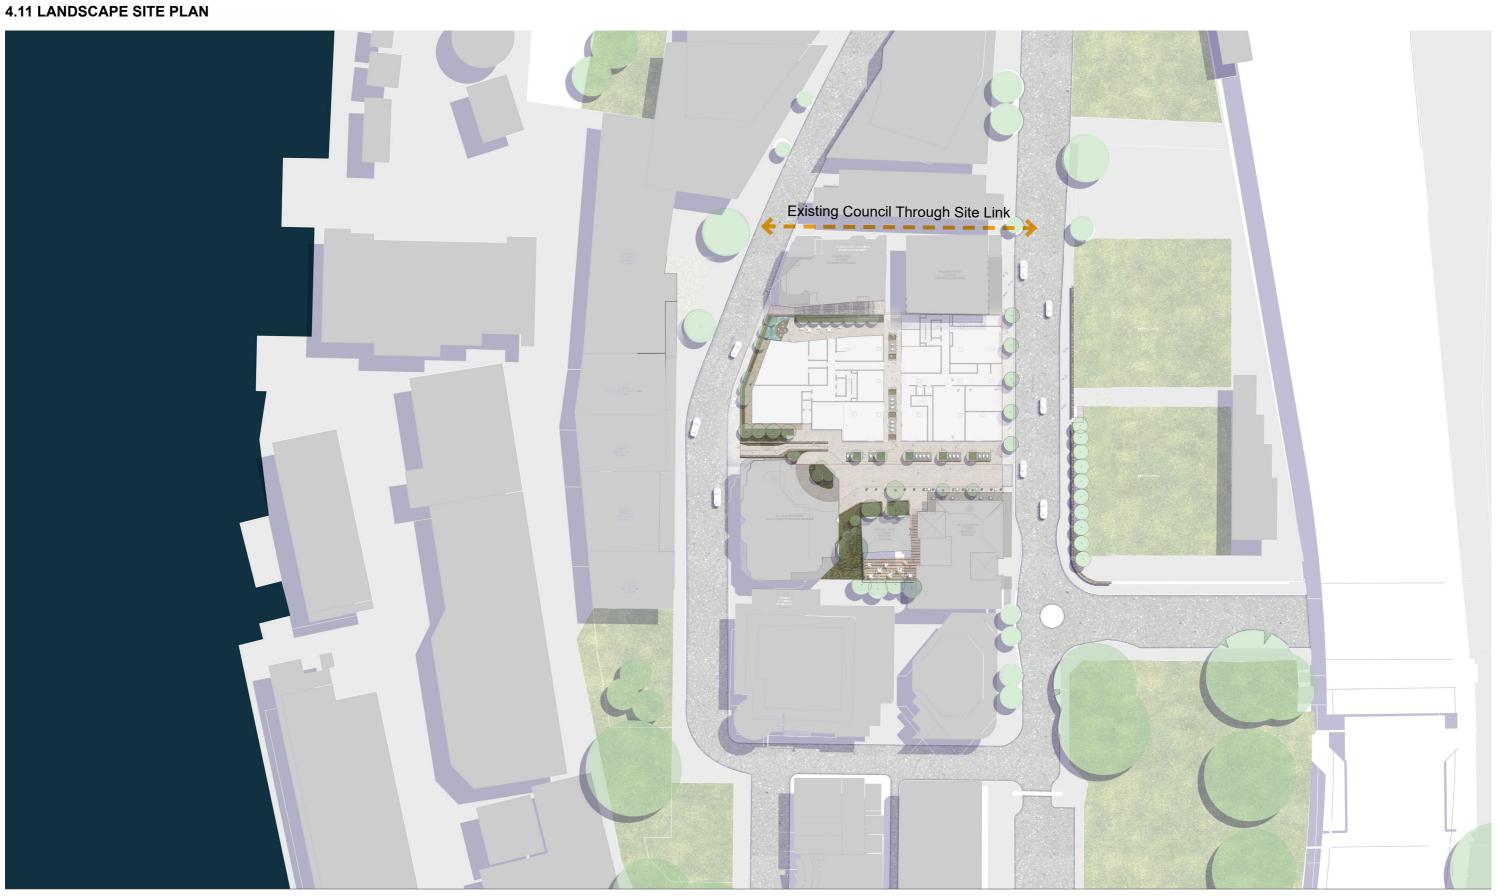


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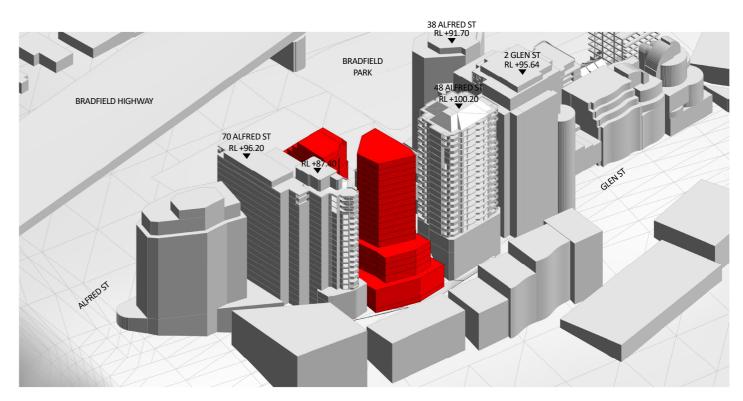


**5.0 DESIGN DESCRIPTION** 

#### 52 ALFRED STREET, MILSONS POINT


#### 5.1 PROPOSED ENVELOPE




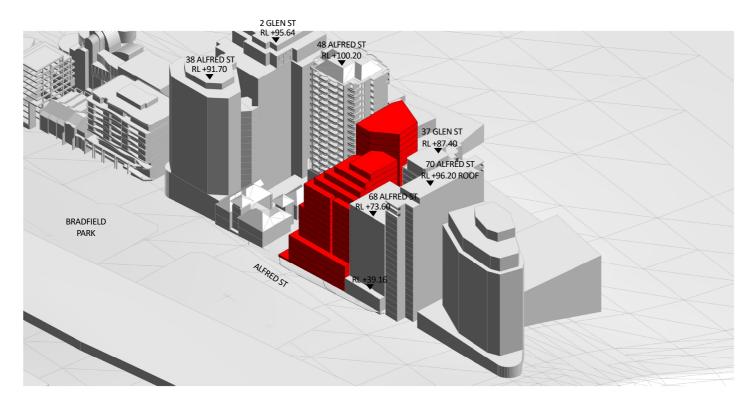

PROPOSED ENVELOPE Northwest View from Glen Street

PROPOSED ENVELOPE Northeast View from Alfred Street

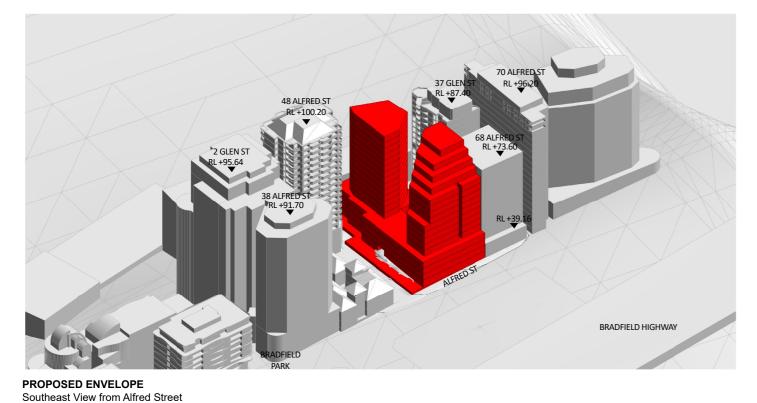

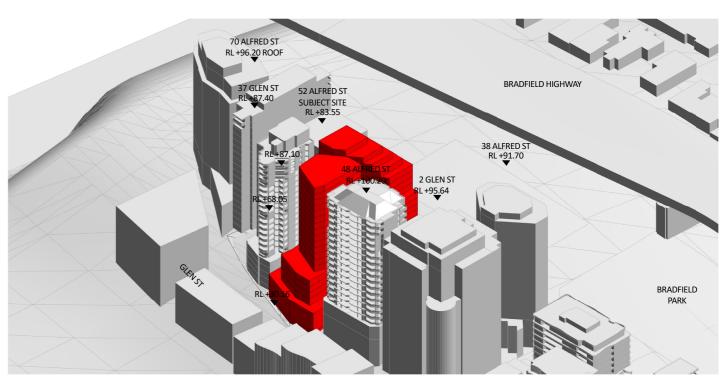


PROPOSED ENVELOPE Southwest View from Glen Street

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#### **5.2 DESIGN DESCRIPTION**

The building is comprised of 3 predominant forms, a part 2 and part 4 storey high podium, 17-storey terraced tower form fronting Alfred Street and 22 storeys (inclusive of the 4 storey podium) tower component fronting Glen Street. The 2 storey podium to Alfred Street assists in defining the street edge, creating a continuous active frontage to the through site link. The stepped tower form terraces away from Alfred Street from 14 to 17 stories, reducing the bulk and perceptible height and aligns to the adjacent developments along Alfred Street.


The tower fronting Glen Street extends to an effective height of 22 storeys, aiding the abrupt transition in height between 37 Glen St and 48 Alfred St. The proposed tower chamfered setbacks reduces adverse impacts of amenity to the neighbouring residents.



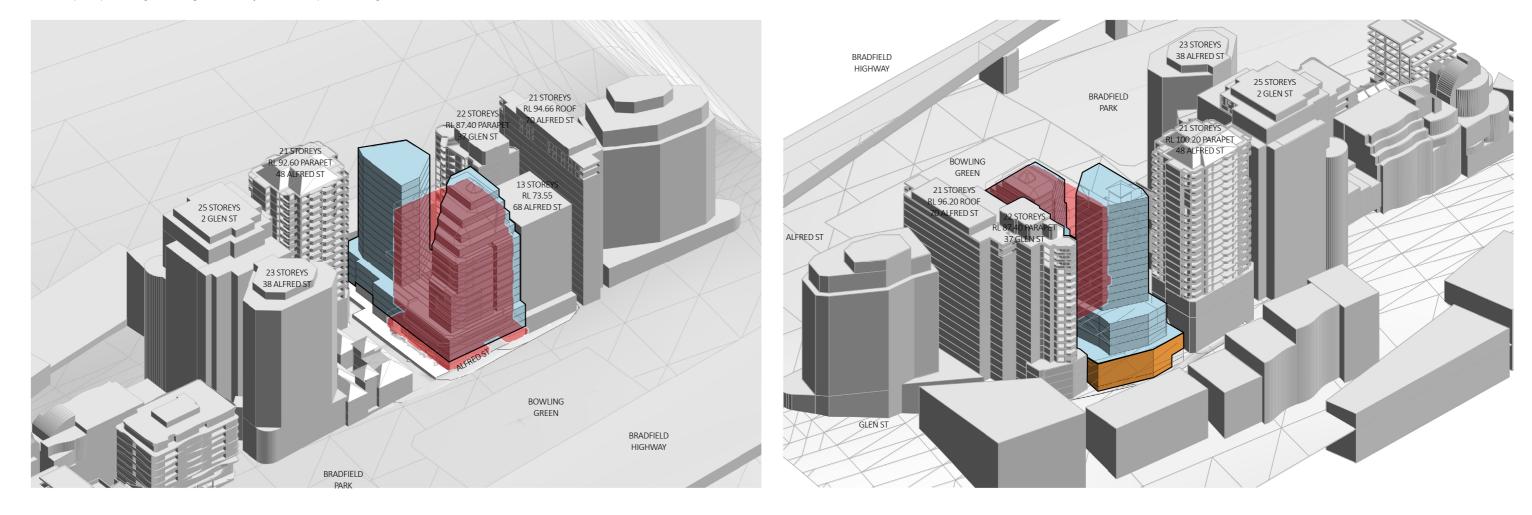


52 ALFRED STREET MILSONS POINT



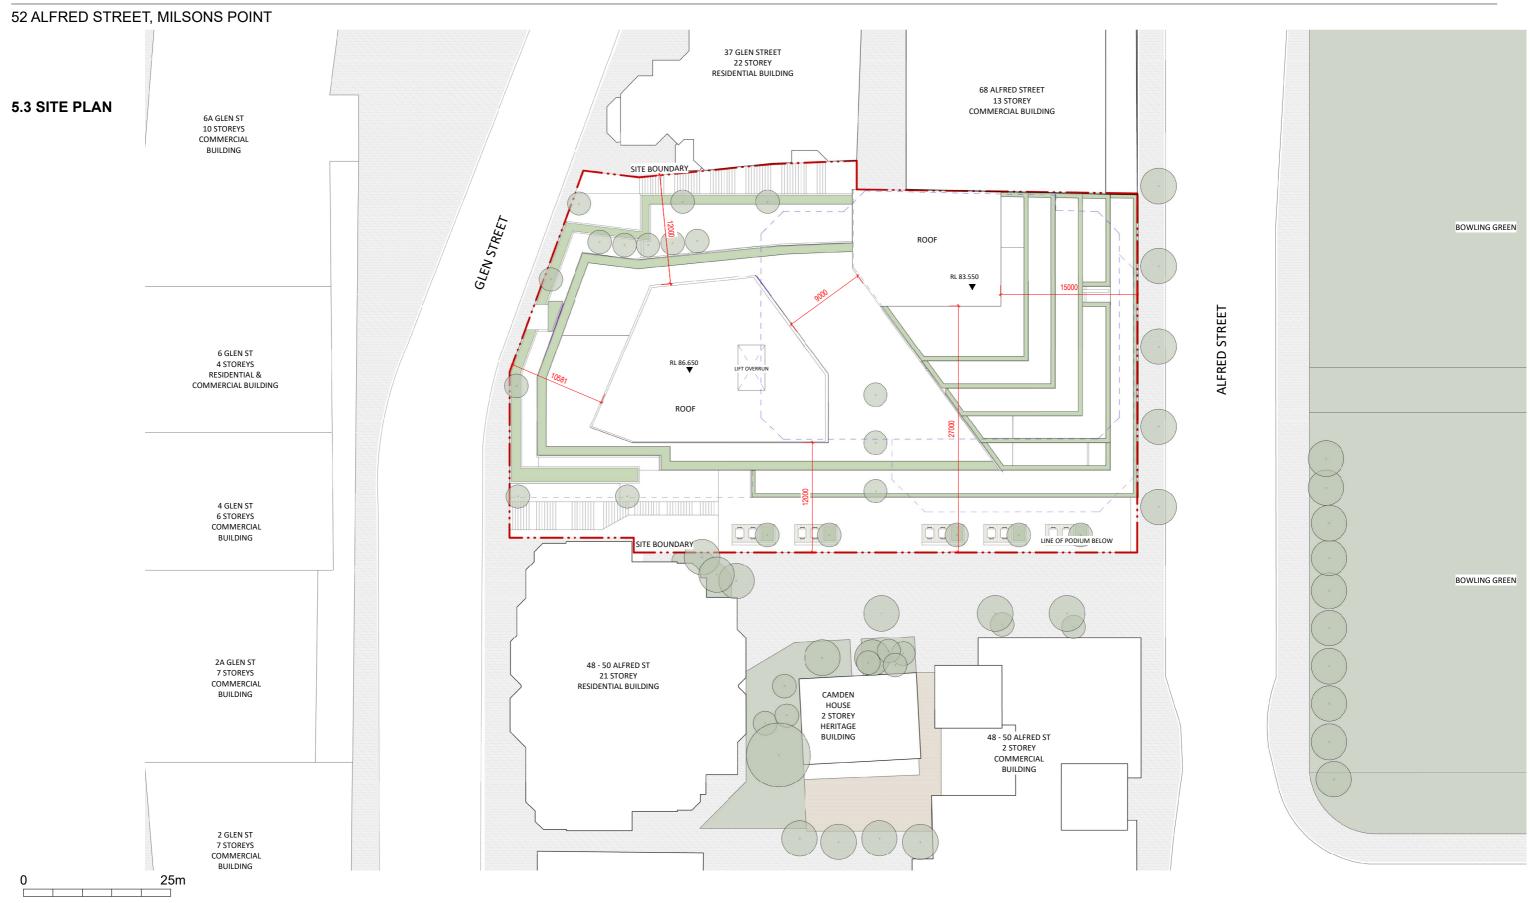


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# Koichi Takada Architects

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#### 5.10 SOLAR ACCESS & CROSS VENTILATION
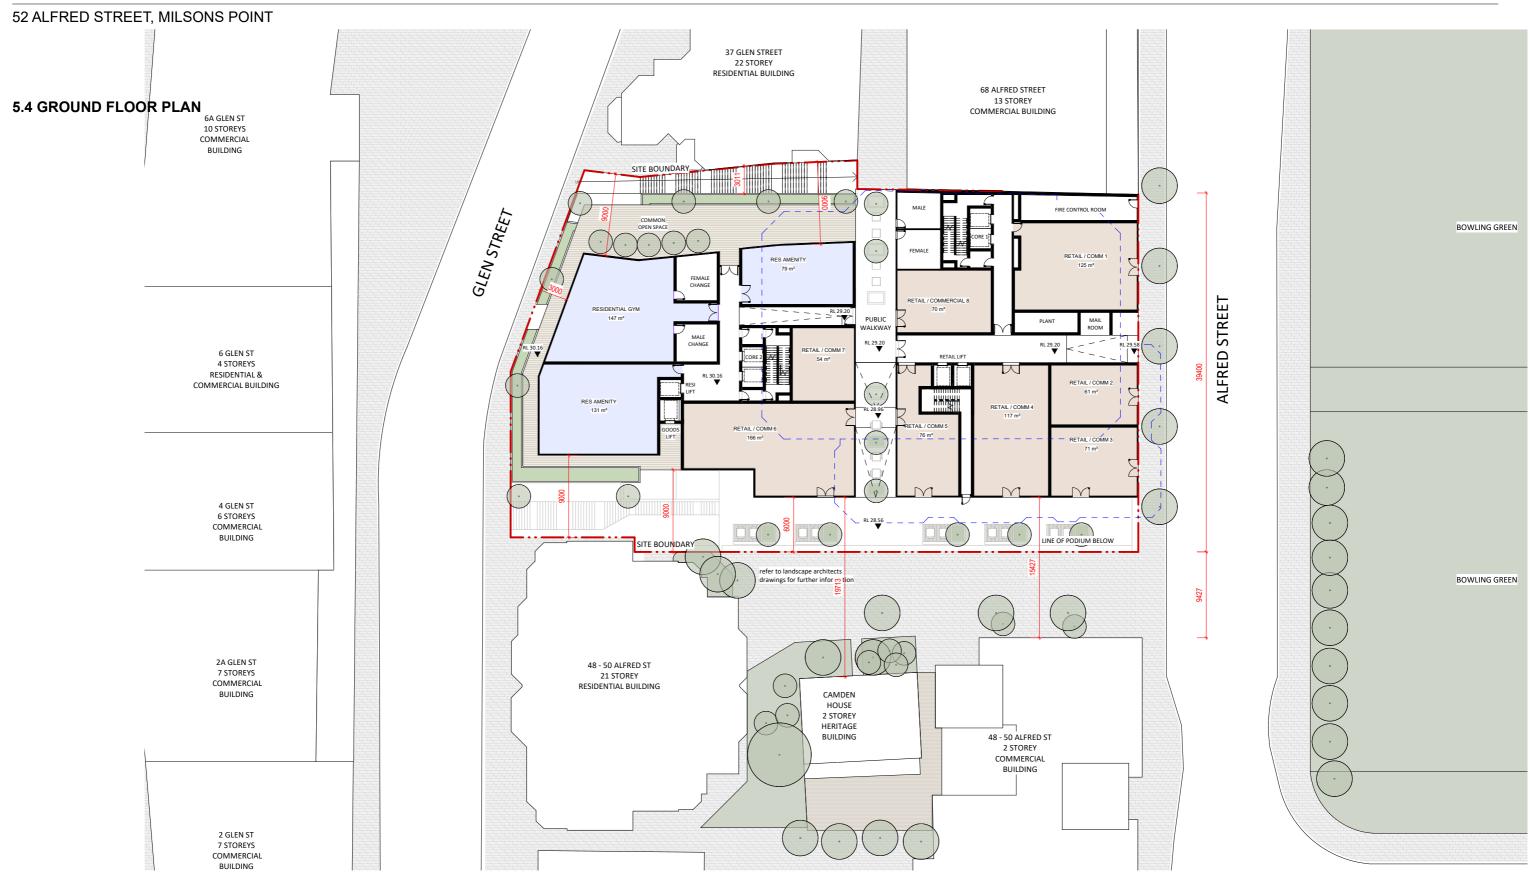
#### SOLAR ACCESS

90 units from a total of 125 (72%) units receive a minimum 2 hours of direct sun to both glazing and private open space between 9am and 3pm on June 21.
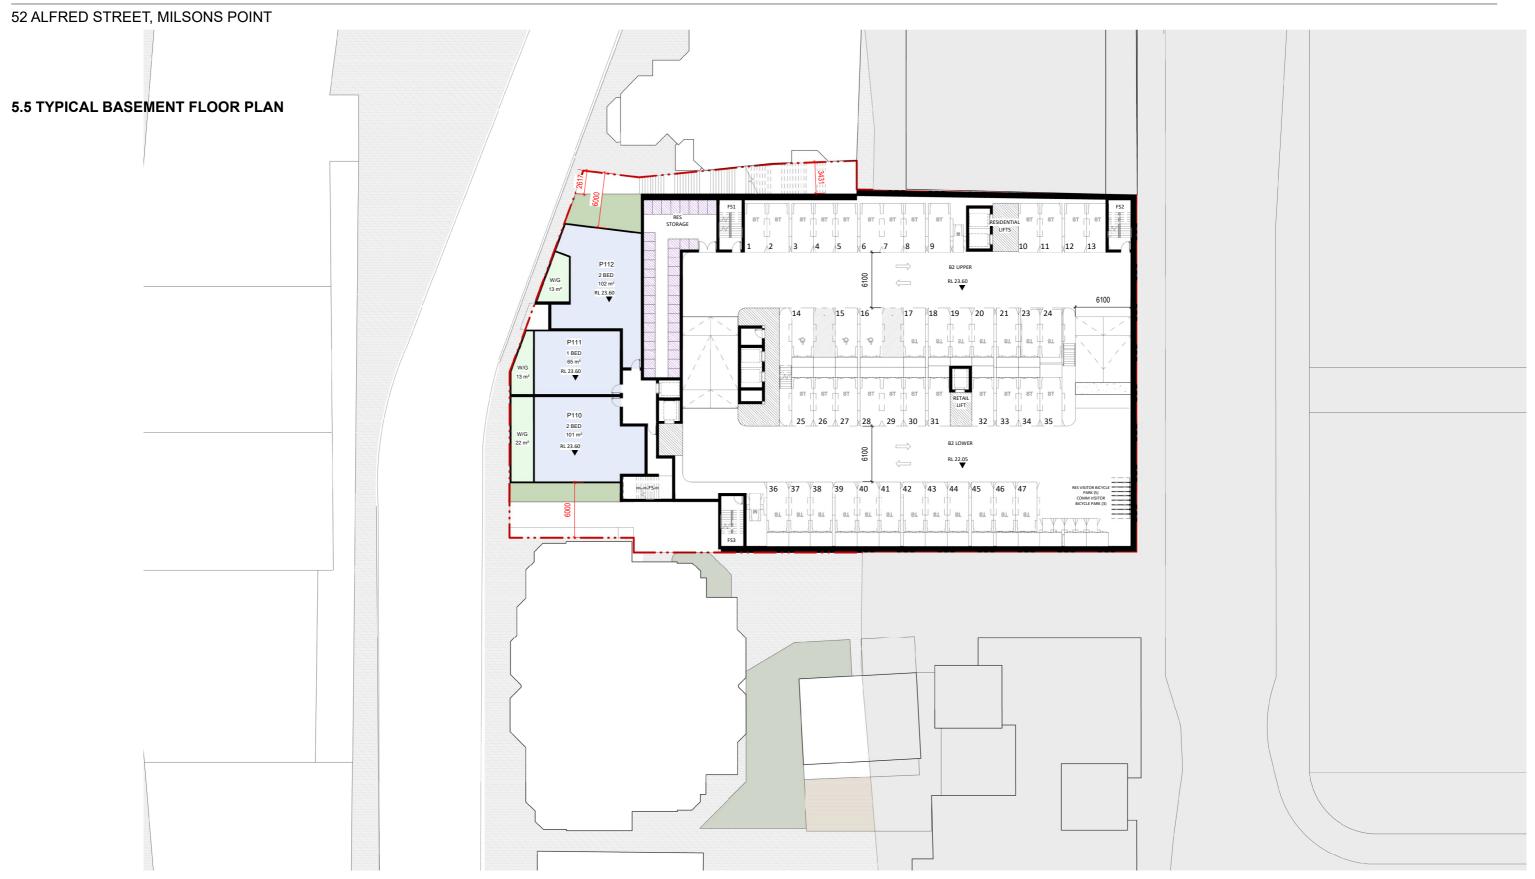
#### **CROSS VENTILATION**

43 units out of a total 69 (62%) are cross ventilated up to 9 storeys. Please see SEPP 65 Amenity: Solar Access and Natural Ventilation report for further information

This is in compliance with ADG criterion in which "at least 60% of apartments are naturally cross ventilated in the first 9 storeys of the building".

Indicative building outline demonstrating ADG compliance

> 2 hours direct sunlight

**Cross ventilated apartment** 



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#### **5.11 ELEVATION DIAGRAMS**

#### FAÇADE FRONT HEIGHT ALIGNMENT


73.60).


The predominant visual bulk of the building presented to Alfred St has a perceptible height of RL 74.25 before

beginning to step back at higher levels. This height aligns with the neighbouring development at 68 Alfred St (RL

#### PODIUM HEIGHT ALIGNMENT

Podium heights along Alfred St vary slightly but typically sit approximately 10m/3 storeys above the natural ground line. The proposed height of the podium on the Alfred St frontage of the development adheres to this principle and is consistent with that of the surrounding developments in order to preserve a visually unified street frontage. Neighbouring developments currently present tower setbacks of 0-3m from Alfred St. The proposed development sits comfortably within this range - with a setback of 2m, the strong articulation of the sandstone podium provides depth and variety to the mass.

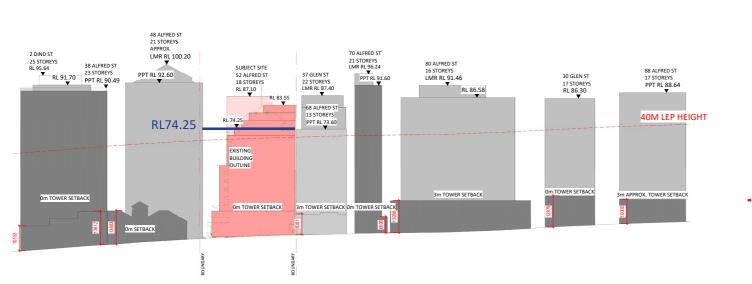

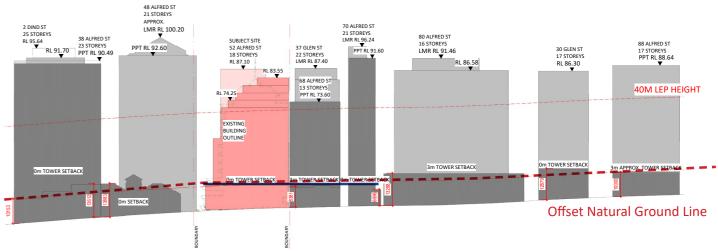

52 ALFRED STREET, MILSONS POINT


#### 5.12 SECTIONS

#### LONG SECTION

									ASSUMED LIFT MACHINE ROC RL 100.20	M	
								48 ALFRED 21 STOREY			
	E	KISTING BUILDING	OUTLINE -							T.	
				NI II							
				BUILDING A		RL 87.10	RL 86.	.65 BUILDING B		STOREYS	
					P OF PARAPET	r		RESIDENTIAL			
	STOREYS			RL 83.55 / `RL	83.75				╺╼╪╴╤╶╤╶╴╴╴╴	18	LEVEL 17_ FFL 83.550
	17		RL 80.45	, RESIDENTIAL				RESIDENTIAL		17	LEVEL 16 FFL 80.450
	16	RL	77.35	RESIDENTIAL				RESIDENTIAL		16	LEVEL 15 FFL 77.350
	15	RL 74.25		RESIDENTIAL				RESIDENTIAL		15	
40M LEP HEIGHT LIMIT	14		DENTIAL	RESIDENTIAL	┥┥╴			RESIDENTIAL	┲╋═╵╪╴╞═┼╴╴──╶╶──	14	LEVEL 14_FFL_74.250
					╉╺┽╴╴	==			┲╋═╺╪╾╞═┈╴╴╴╴		LEVEL13_FFL 71.150
	13	RESI	DENTIAL	RESIDENTIAL				RESIDENTIAL		13	LEVEL 12 FFL 68.050
	12	RESI	DENTIAL	RESIDENTIAL						12	LEVEL 11 FFL 64.950
	11	RESI	DENTIAL	RESIDENTIAL				RESIDENTIAL		11	
	10 ·	RESI	DENTIAL	RESIDENTIAL	╉═╬╎──			RESIDENTIAL	╋╋═┼╪╴╞═┼╴╴┈╴╴┈	10	LEVEL 10_FFL 61.850
					┥┥╴				┲╋═╶╧╴╞═╙╴╴╴╴╴		LEVEL 09_FFL_58.750
	9	RESI	DENTIAL	RESIDENTIAL				RESIDENTIAL		9	LEVEL 08_FFL 55.650
	8	RESI	DENTIAL	RESIDENTIAL				□ □ RESIDENTIAL		8	LEVEL 07 FFL 52.550
	7	RESI	DENTIAL	RESIDENTIAL				RESIDENTIAL		86	
		RESI	DENTIAL	RESIDENTIAL	╉═╣─				╆╋═╶╧╴╘═┈╶╶┈╴╴	6	<u>LEVEL 06 FFL</u> 49.450
	·	┍╶╝└───┟───			╉═┥─	-		<u> </u>			LEVEL 05_FFL 46.350
	5		DENTIAL	RESIDENTIAL						5	LEVEL 04_FFL_43.250
	4	RESI	DENTIAL		CON	IMERCIAL			RESIDENTIAL	4	LEVEL 03_FFL_40.150
	3	RESI	DENTIAL		CON	IMERCIAL			RESIDENTIAL	3	LEVEL 02 FFL 37.050
	2		DENTIAL		CON	IMERCIAL			RESIDENTIAL	2	
BRADFIELD PARK					TT						LEVEL 01_ FFL 33.950
BOWLING GREEN		RETAIL/COMM 1		RETAIL/COMM 8	PUBLIC WALKWAY	RES AN	MENITY	FEMALE CHANGE	RESIDENTIAL GYM RL 30.16	1	UPPER GROUND_FFL_30.160
	·										LOWER GROUND FFL 28.600
				ARPARK B1						=	BASEMENT 01_FFL 26.700
			C/	ARPARK B2					RESIDENTIAL	=	BASEMENT_02_FFL_23.600
			0	ARPARK B3					RESIDENTIAL	GLEN STRE	ETBASEMENT 03 FFL 20.500
									соммекстац – т	RL 18.0	
			C/	ARPARK B4							BASEMENT 04 FFL-16.500
		DARY								DARY	

52 ALFRED STREET MILSONS POINT



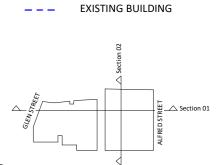

SERVICE / BASEMENT LEVEL

COMMERCIAL/RETAIL STOREY

**RESIDENTIAL STOREY** 

RETAIL STOREY


## LEGEND

37 GLEN STREET 22 STOREYS RL 82.70

48 ALFRED ST 21 STOREYS RIDGE RL 96.63

#### 52 ALFRED STREET, MILSONS POINT

#### 5.12 SECTIONS

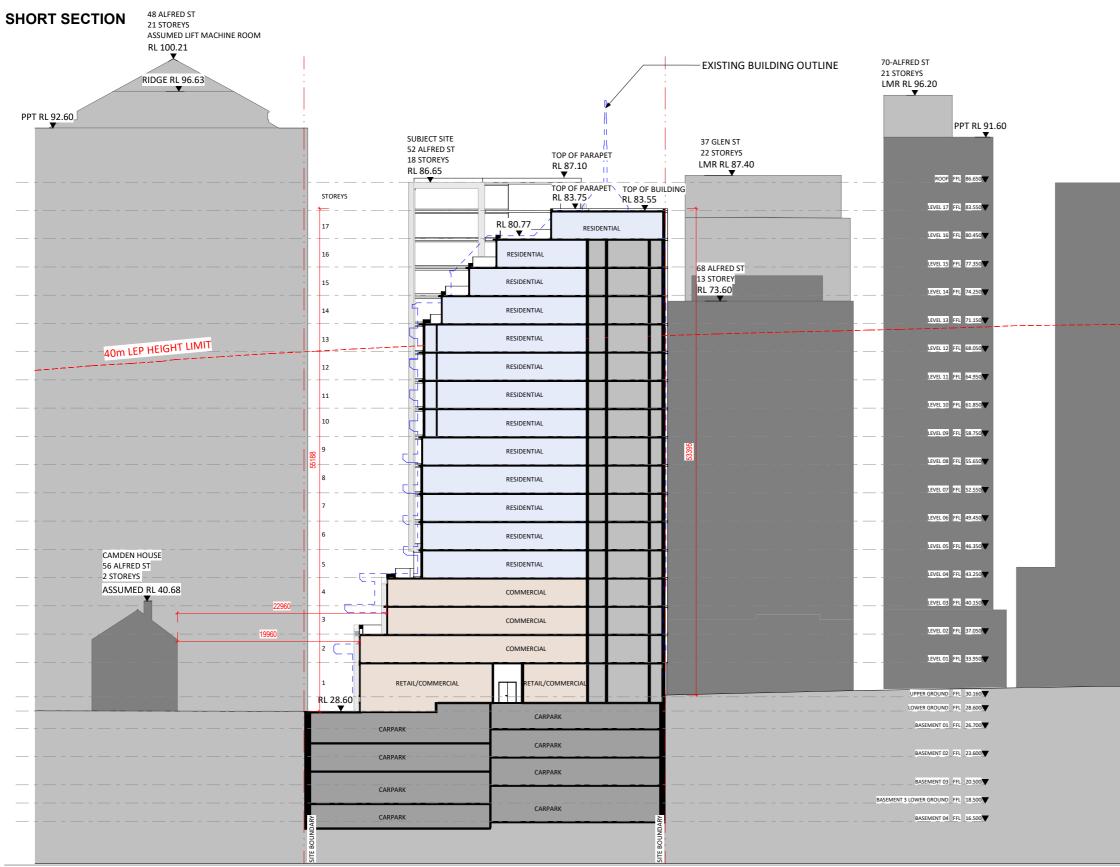

52 ALFRED STREET MILSONS POINT



LEGEND

\_ \_ \_

SERVICE / BASEMENT LEVEL

COMMERCIAL/RETAIL STOREY

∧ Section 01

**RESIDENTIAL STOREY** 

**RETAIL STOREY** 


Koichi Takada

**Architects** 

EXISTING BUILDING




#### 52 ALFRED STREET, MILSONS POINT

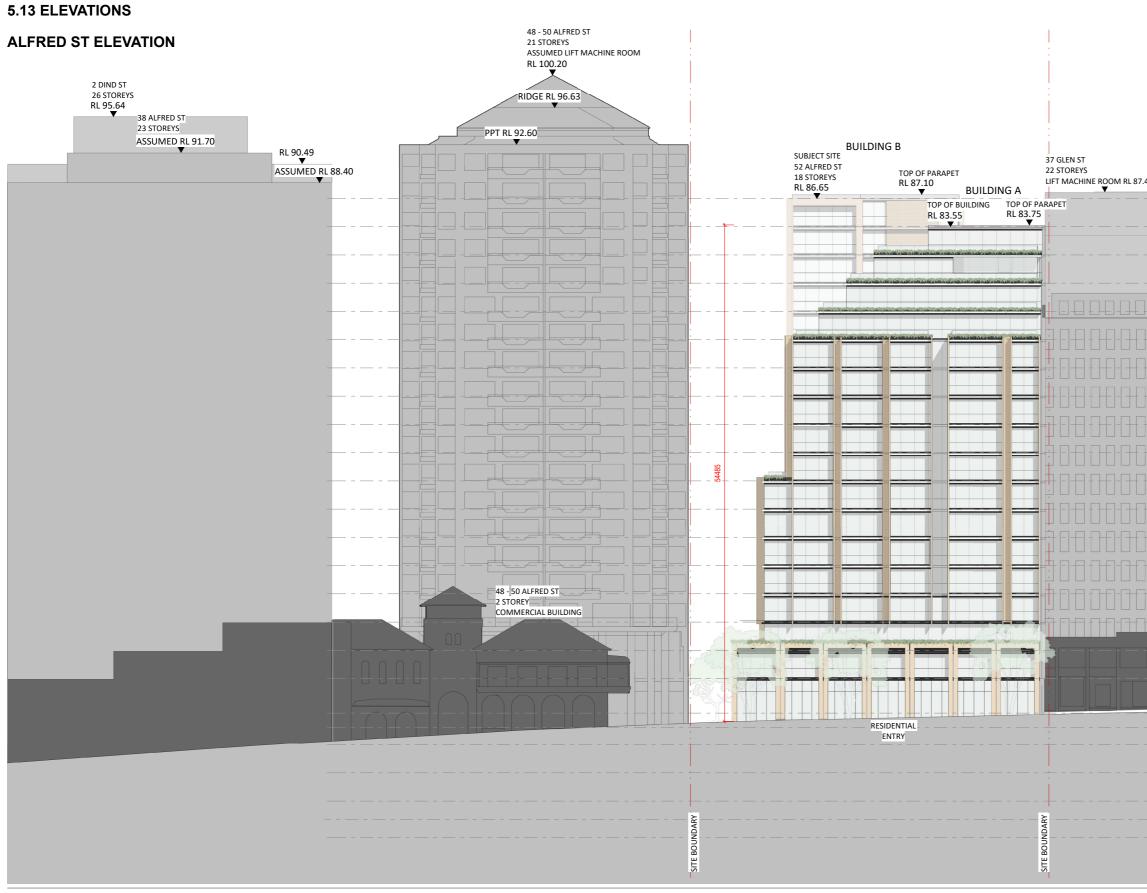

52 ALFRED STREET MILSONS POINT

	ALFRED ST STOREYS		
LM	1R RL 96.20 ▼		
	PPT RL	L 91.60	
7.40			
		PPT RL 86.5	8
	LEVEL 17 FFL	83.550	
	LEVEL 16 FFL	80.450	
	LEVEL 15 FFL	77.350	
PPT RL 73.60	LEVEL 14 FFL	74.250	
]	LEVEL 13 FFL	71.150	
┇╋┇╋┇┯╺╶┥	LEVEL 12 FFL	68.050	
┇╋┇╋┇┯╺╺┥	LEVEL 11 FFL	64.950 <b>-</b>	
]	LEVEL 10 FFL	61.850	
]	LEVEL 09 FFL	58.750	
] ] ] ] ] ] ] ] ] ] ] ] ] ] ] ] ] ] ] ]	LEVEL 08 FFL	55.650	
┇╋┇╋┇┯╺╶┥	LEVEL 07 FFL	52.550	
	LEVEL 06 FFL	49.450	
	LEVEL 05_FFL		
	LEVEL 04 FFL		
	LEVEL 03 FFL		
	LEVEL 02 FFL		
	LEVEL 01 FFL	33.950	
PUBLIC	UPPER GROUND FFL		
THROUGH			
	BASEMENT 02 FFL	23.600	
	BASEMENT 03 FFL	20.500	
	BASEMENT 3 LOWER GROUND FFL	18.500	
	BASEMENT 04 FFL	16.500	

52 ALFRED STREET, MILSONS POINT

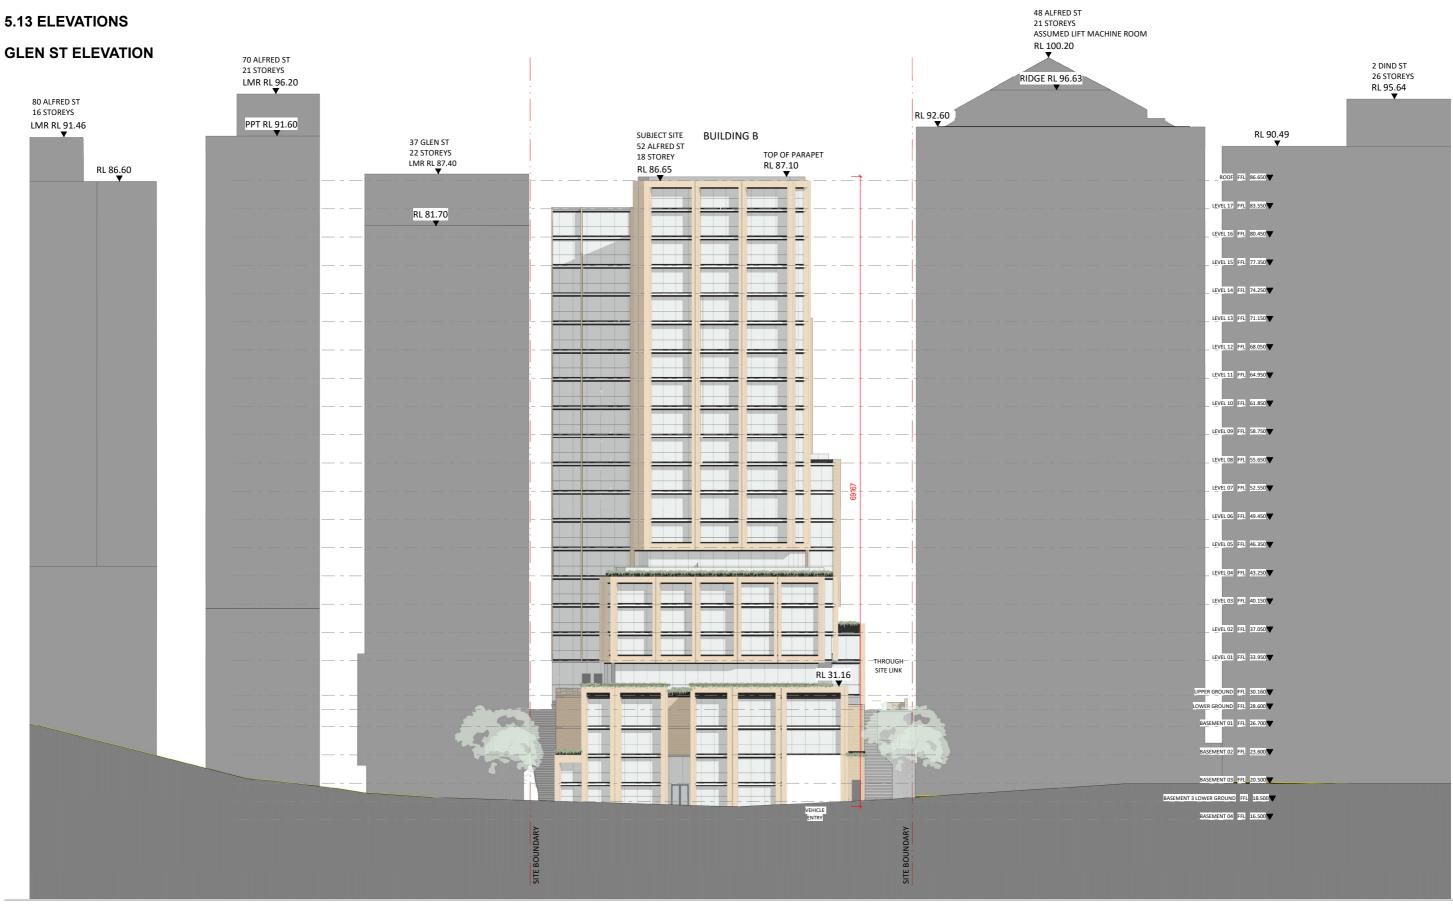


52 ALFRED STREET MILSONS POINT

52 ALFRED STREET, MILSONS POINT

#### 5.13 ELEVATIONS

#### SOUTH ELEVATION

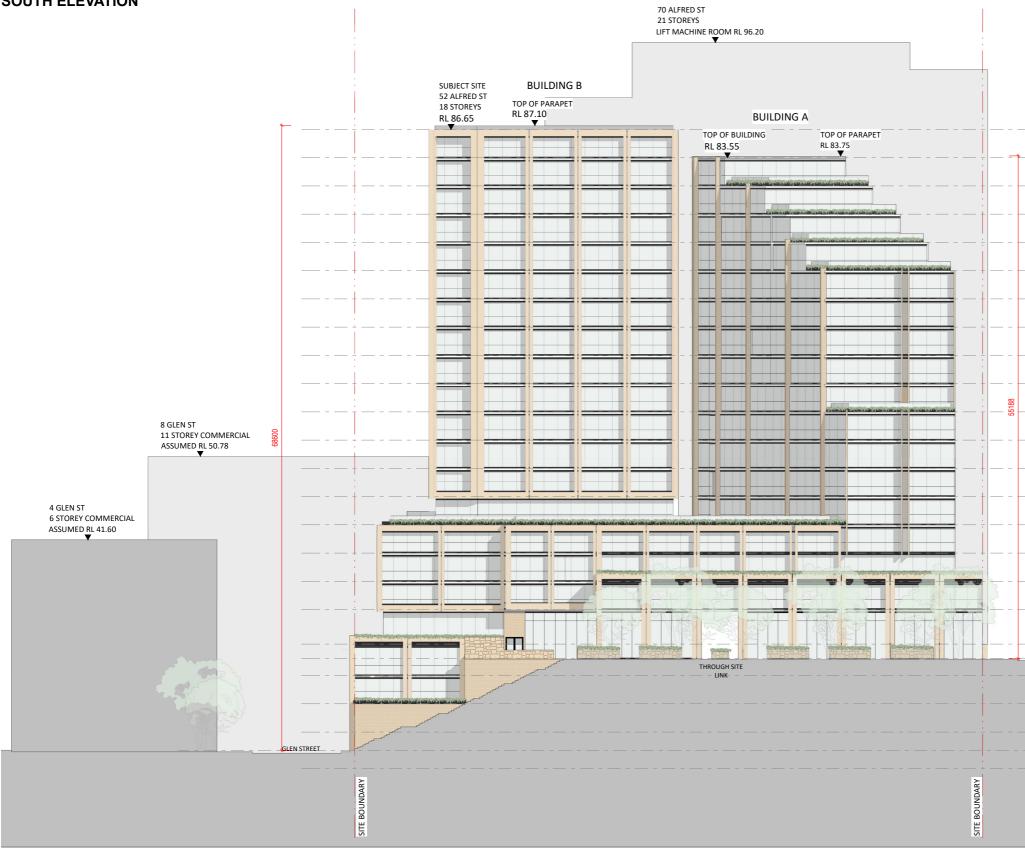

52 ALFRED STREET MILSONS POINT

# Koichi Takada Architects

_	_		LEVEL 1	7_FFL	83.550	,
	_		LEVEL 1	6_FFL	80.450	,
	_		LEVEL 1	5_FFL	77.350	,
	_		LEVEL 1	4_FFL	74.250	,
	_		LEVEL 1	3_FFL	71.150	,
	_		LEVEL 1	2_FFL	68.050	,
	_		LEVEL 1	1_FFL	64.950	,
_	_		L <u>EVEL 1</u>	0_FFL	61.850	,
	_		LEVEL	9_FFL	58.750	,
	_		L <u>EVEL O</u>	18_FF <u>L</u>	55.650	,
	_			17_FFL	52.550	,
_	_	_	LEVEL C	16_FF <u>L</u>	49.450	,
	_		LEVEL	15_FFL	46.350	,
_	_		L <u>evel o</u>	14_FFL	43.250	,
	_		LEVELO	B_FFL	40.150	and the
_	_		L <u>EVEL C</u>	2_FFL	37.050	
	_		LEVEL	1_FFL	33.950	
	_	UPPER	GROUN	D_FFL	30.160	BRADFIELD PARK BOWLING GREEN
_	_	OWER	GROUN	D FFL	28.600	•
		BASE	EMENT O	1_FFL	26.700	,
		BASE	EMENT O	2 FFL	23.600	•
					20.500	
ENT	3 L	OWER	GROUNE	) FFL	18.500	
		BASE	EMENT 0	4_FFL	16.500	,

ALFRED STREET

6.0 ANALYSIS

52 ALFRED STREET, MILSONS POINT

#### 6.1 AREA SCHEDULE

	LEVEL	GFA RESIDENTIAL	GFA AMENITIES	GFA COMMERCIAL	GFA RETAIL	TOTAL GFA		PARKIN	IG COUNT			UNIT	міх			TOTAL APT.
							СОММ	RETAIL	RESI	MOTORBIKE	Studio	1B	2B	3B	4B	
	BASEMENT 4	0	0	0			4	11	33	1						
	BASEMENT 3	0	0	269		269	-		47	3						
BASEMENT	BASEMENT 3 Upper	266	0	0		266				1			1	1	0	2
	BASEMENT 2	352	0	0		352			47	7		1	2	0	0	3
	BASEMENT 1	352	0	0		352			49	6	0	1	2	0	0	3
	GROUND	0	500	0	867	1367					0	0	0	0	0	0
	LEVEL 1	953	0	771		1724					0	2	2	0	2	6
PODIUM	LEVEL 2	803	0	674		1477					0	2	2	0	2	6
	LEVEL 3	803	0	674		1477					0	1	1	1	2	5
	LEVEL 4	908	0	0		908					0	3	3	3	0	9
	LEVEL 5	908	0	0		908					0	3	3	3	0	9
	LEVEL 6	908	0	0		908					0	3	3	3	0	9
	LEVEL 7	908	0	0		908					0	3	3	3	0	9
	LEVEL 8	858	0	0		858					0	2	3	3	0	8
	LEVEL 9	858	0	0		858					0	2	3	3	0	8
TOWER	LEVEL 10	858	0	0		858					0	2	3	3	0	8
. o . i e . i	LEVEL 11	858	0	0		858					0	2	4	2	0	8
	LEVEL 12	858	0	0		858					0	2	4	2	0	8
	LEVEL 13	745	0	0		745					0	1	5	1	0	7
	LEVEL 14	640	0	0		640					0	1	3	2	0	6
	LEVEL 15	556	0	0		556					0	1	1	3	0	5
	LEVEL 16	492	0	-		492					0	1	1	1	0	3
	LEVEL 17	304	0			304					0	1	1	1	0	3
	TOTALS	14,188	500	2388	867	17,943	4	11	176	18	0	34	50	35	6	125
								191		18	0%	27%	40%	28%	5%	100%

52 ALFRED STREET MILSONS POINT

## 52 ALFRED STREET, MILSONS POINT


#### 6.2 SUN EYE DIAGRAM

MID WINTER 21ST JUNE

9 AM



EXISTING

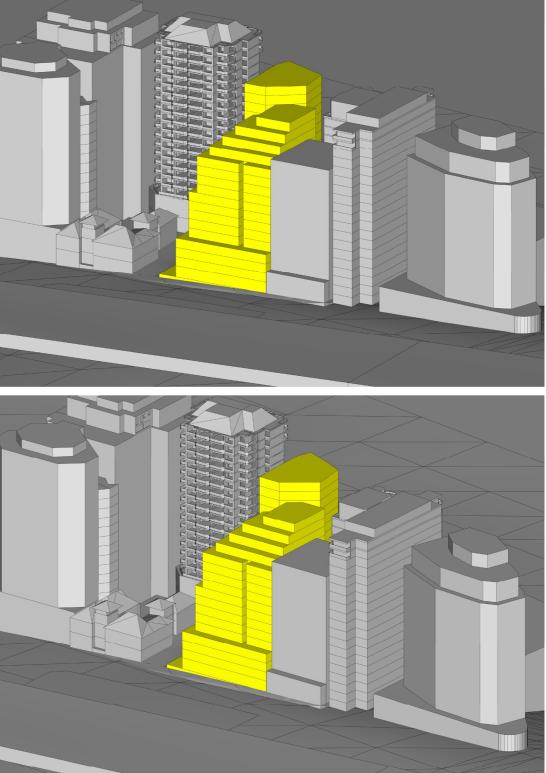

9:30 AM

52 ALFRED STREET MILSONS POINT

PLANNING PROPOSAL FEBRUARY 2023

# PROPOSED


## 52 ALFRED STREET, MILSONS POINT

#### 6.2 SUN EYE DIAGRAM

MID WINTER 21ST JUNE

10 AM



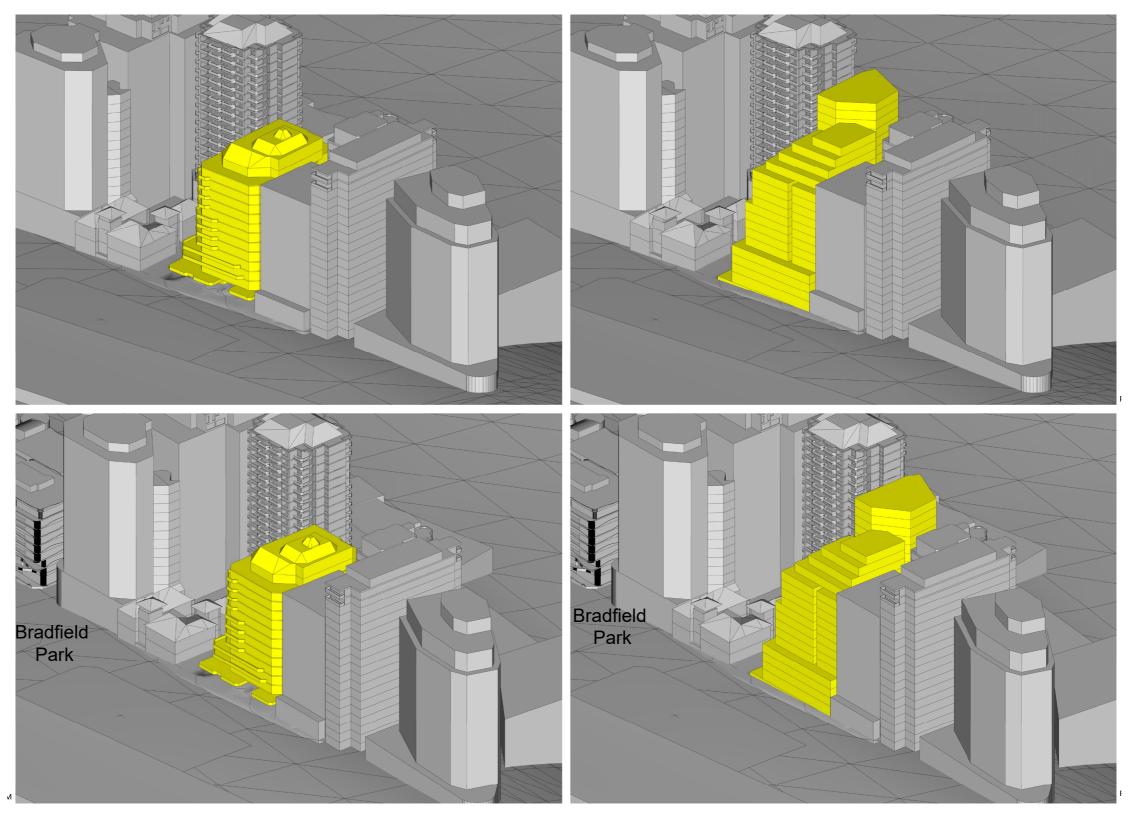

10:30 AM

52 ALFRED STREET MILSONS POINT

PLANNING PROPOSAL FEBRUARY 2023


# PROPOSED


## 52 ALFRED STREET, MILSONS POINT

#### 6.2 SUN EYE DIAGRAM

MID WINTER 21ST JUNE

11 AM

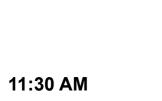

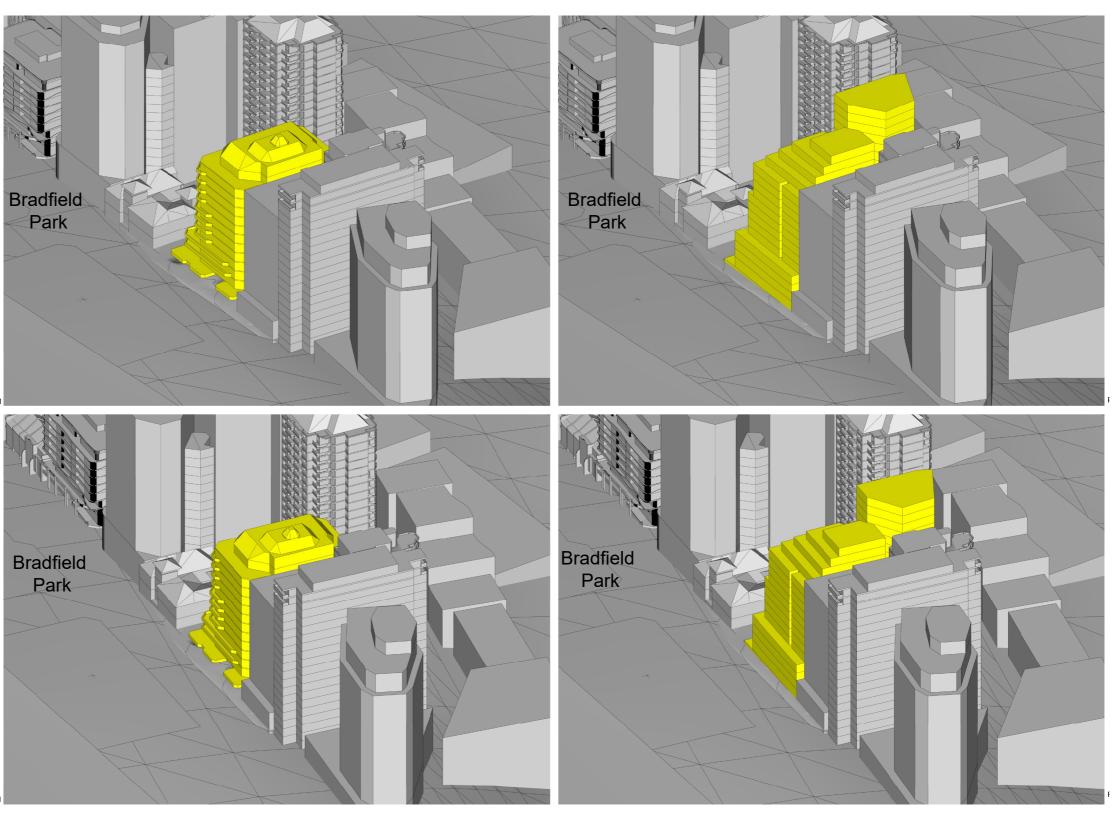

EXISTING

52 ALFRED STREET MILSONS POINT

PLANNING PROPOSAL FEBRUARY 2023

# PROPOSED


## 52 ALFRED STREET, MILSONS POINT

#### 6.2 SUN EYE DIAGRAM

MID WINTER 21ST JUNE

12 PM



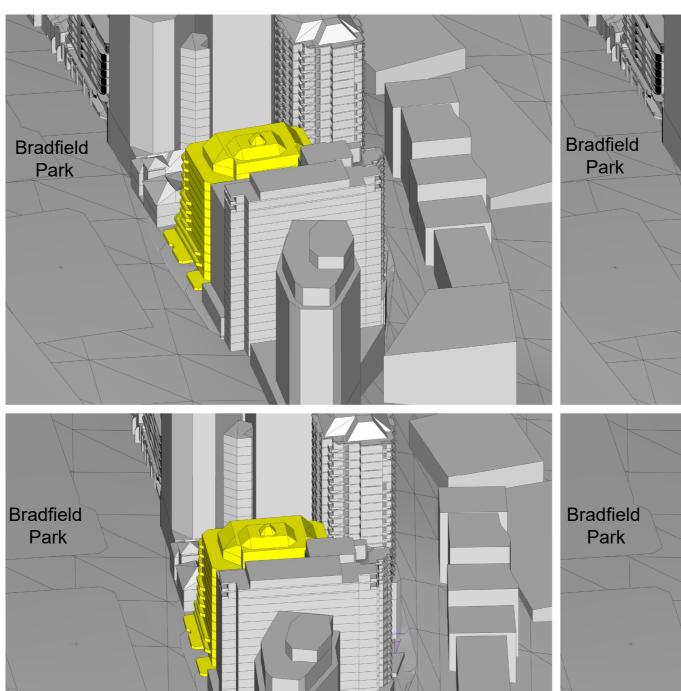


EXISTING

52 ALFRED STREET MILSONS POINT

PLANNING PROPOSAL FEBRUARY 2023

# PROPOSED

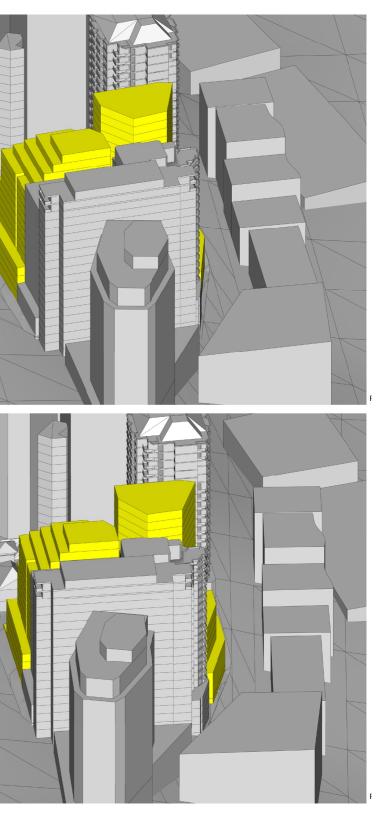


## 52 ALFRED STREET, MILSONS POINT

#### 6.2 SUN EYE DIAGRAM

MID WINTER 21ST JUNE

1 PM

1:30 PM

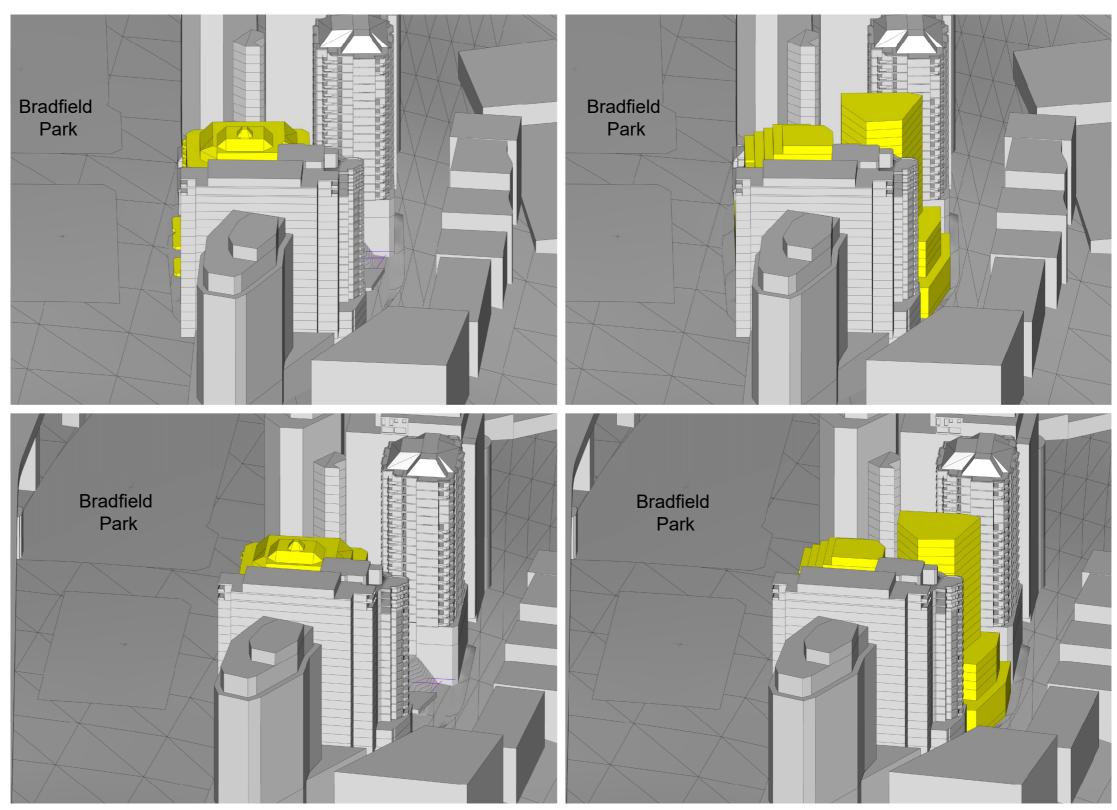

EXISTING

52 ALFRED STREET MILSONS POINT

PLANNING PROPOSAL FEBRUARY 2023




## 52 ALFRED STREET, MILSONS POINT

#### 6.2 SUN EYE DIAGRAM

MID WINTER 21ST JUNE

2 PM

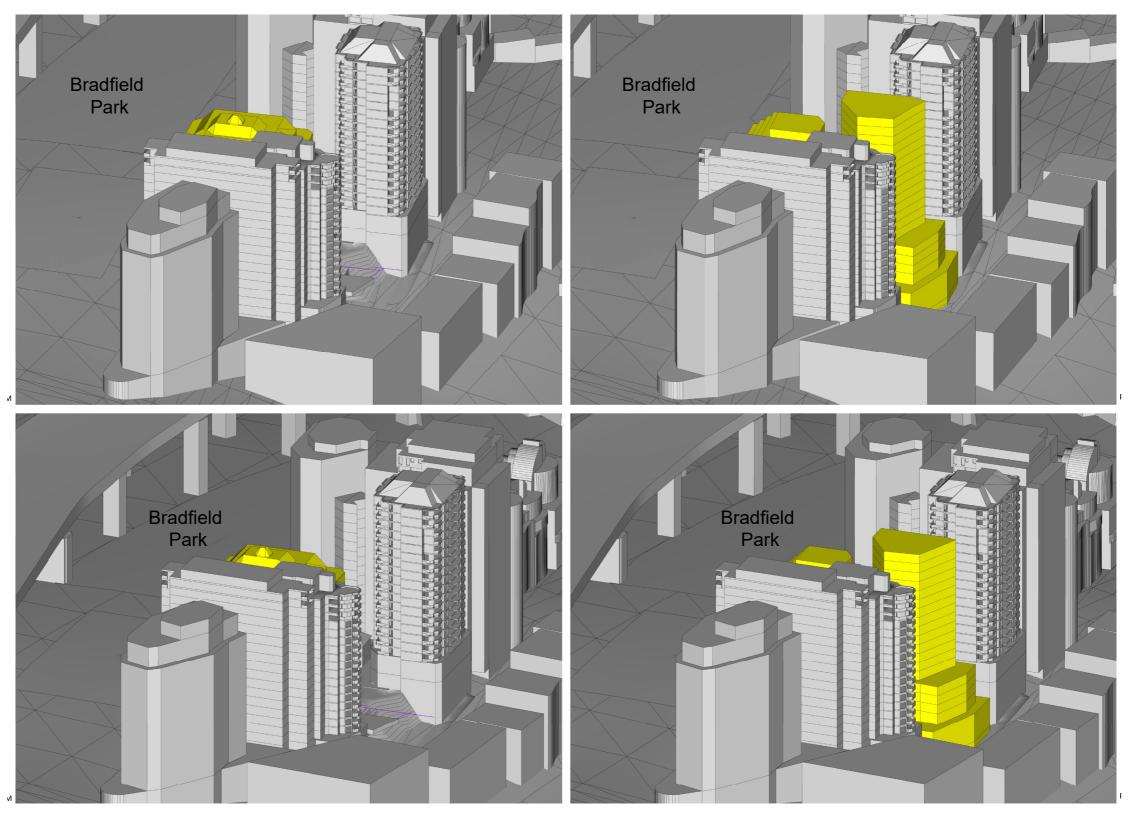

EXISTING

2:30 PM

52 ALFRED STREET MILSONS POINT


# PROPOSED

## 52 ALFRED STREET, MILSONS POINT

#### 6.2 SUN EYE DIAGRAM

MID WINTER 21ST JUNE

EXISTING

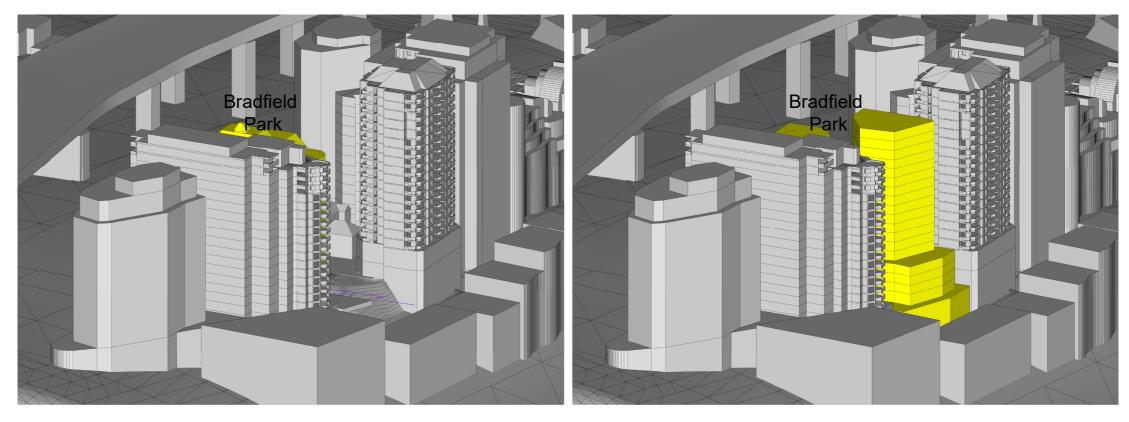

3 PM

52 ALFRED STREET MILSONS POINT

PLANNING PROPOSAL FEBRUARY 2023


# PROPOSED

#### 52 ALFRED STREET, MILSONS POINT


#### 6.3 SHADOW STUDIES

#### MID WINTER 21st JUNE

There is zero additional overshadowing from 9am - 3pm on 21 June to the surrounding context and the prominent Bradfield Park. Furthermore, there is reduced overshadowing in the range of 14m<sup>2</sup> to 25m<sup>2</sup> from 1:30pm to 2:30pm.

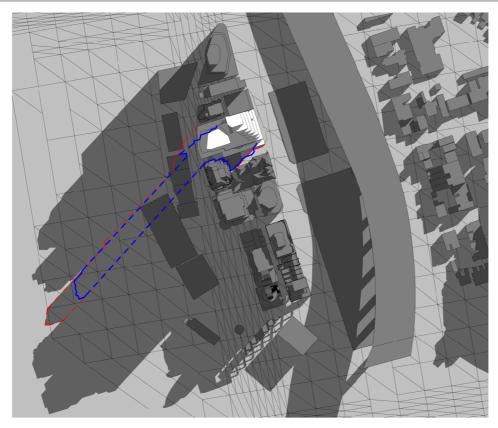

21st JUNE, 9 AM

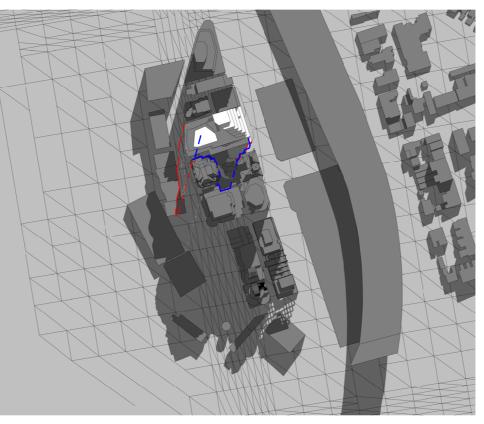






21st JUNE, 12 PM


21st JUNE, 10 AM

 Existing Building Shadow
 Proposed Building Shadow
 North Neighbouring Shadow

52 ALFRED STREET MILSONS POINT

PLANNING PROPOSAL FEBRUARY 2023

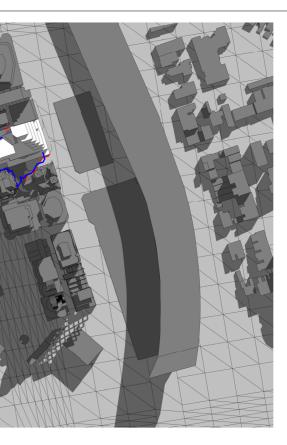

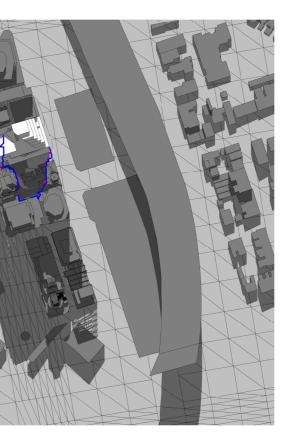


#### 52 ALFRED STREET, MILSONS POINT


#### 6.3 SHADOW STUDIES

#### MID WINTER 21st JUNE


There is zero additional overshadowing from 9am - 3pm on 21 June to the surrounding context and the prominent Bradfield Park. Furthermore, there is reduced overshadowing in the range of  $14m^2$  to  $25m^2$  from 1:30pm to 2:30pm.

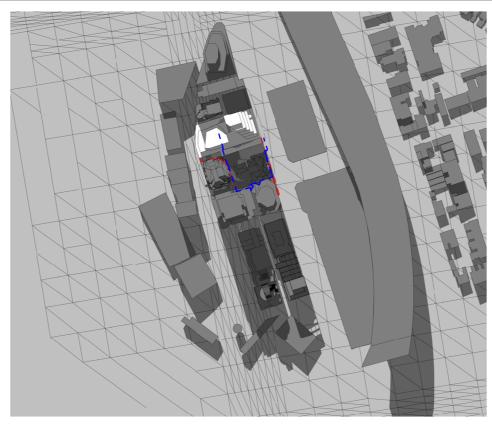


21st JUNE, 1 PM

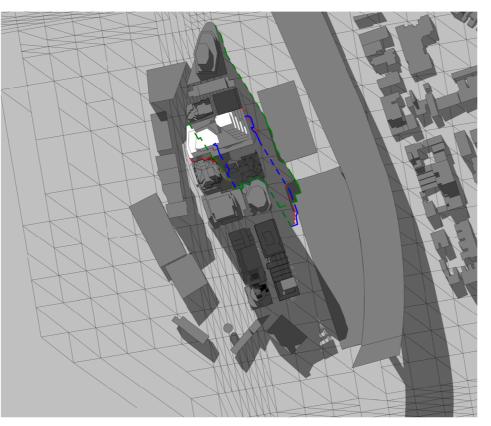

21st JUNE, 2 PM

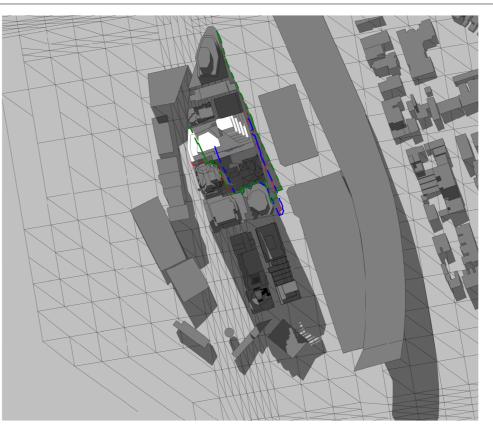

21st JUNE, 1.30PM

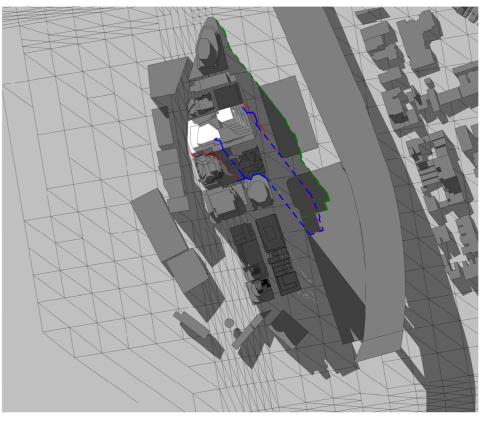

21st JUNE, 2.30 PM

52 ALFRED STREET MILSONS POINT

Existing Building Shadow

Proposed Building

North Neighbouring

Shadow

Shadow


PLANNING PROPOSAL FEBRUARY 2023

## 52 ALFRED STREET, MILSONS POINT

#### 6.3 SHADOW STUDIES

#### MID WINTER 21st JUNE

There is zero additional overshadowing from 9am - 3pm on 21 June to the surrounding context and the prominent Bradfield Park. Furthermore, there is reduced overshadowing in the range of 14m<sup>2</sup> to 25m<sup>2</sup> from 1:30pm to 2:30pm.

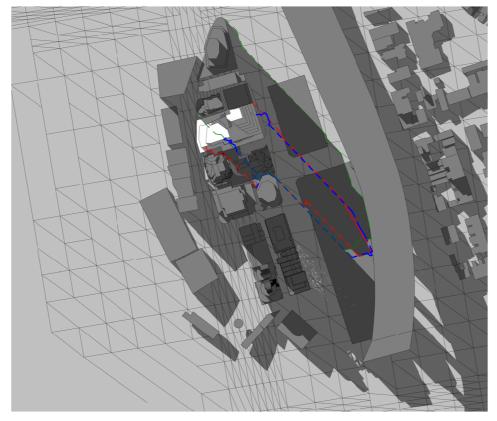

21st JUNE, 3.00 PM

Existing Building Shadow
Proposed Building Shadow
North Neighbouring Shadow

52 ALFRED STREET MILSONS POINT


PLANNING PROPOSAL FEBRUARY 2023

#### 62


#### 52 ALFRED STREET, MILSONS POINT


#### 6.4 DETAILED OVERSHADOWING ANALYSIS (1-3PM)

MID WINTER 21st JUNE

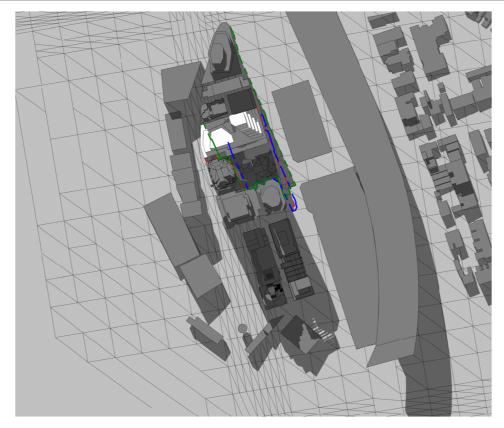

21st JUNE, 1.30 PM DETAILED SHADOW STUDY

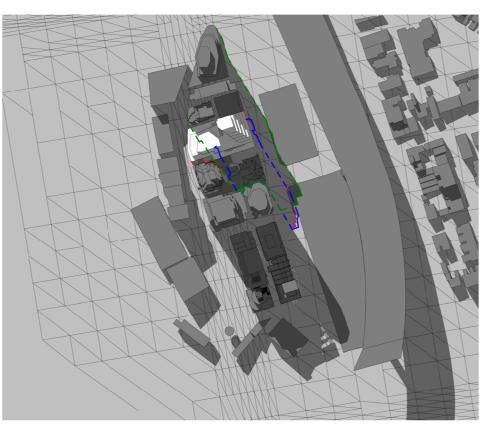


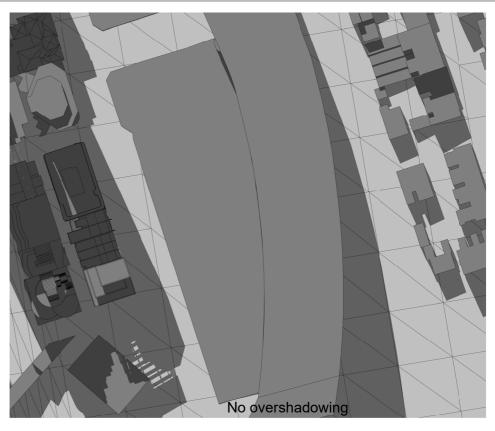

21st JUNE, 1.30 PM DETAILED SHADOW STUDY IN DETAIL

Existing Building Shadow

- Proposed Building Shadow \_ \_
- North Neighbouring Shadow \_ \_ \_

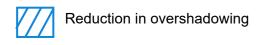




21st JUNE, 2PM DETAILED SHADOW STUDY IN DETAIL

52 ALFRED STREET MILSONS POINT

- - -

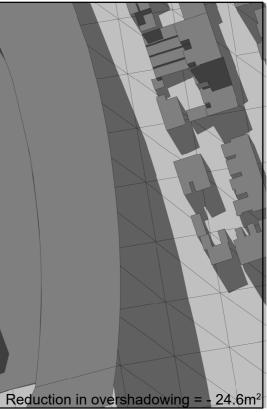





#### 52 ALFRED STREET, MILSONS POINT


#### 6.4 DETAILED OVERSHADOWING ANALYSIS (1-3PM)

MID WINTER 21st JUNE

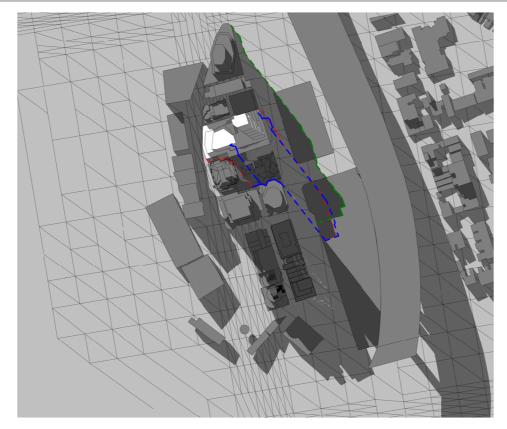

21st JUNE, 2.30 PM DETAILED SHADOW STUDY

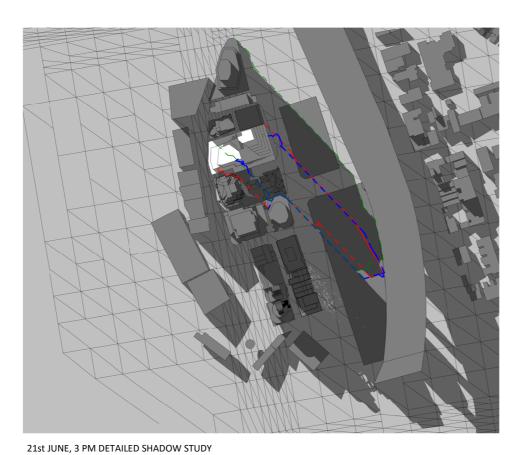

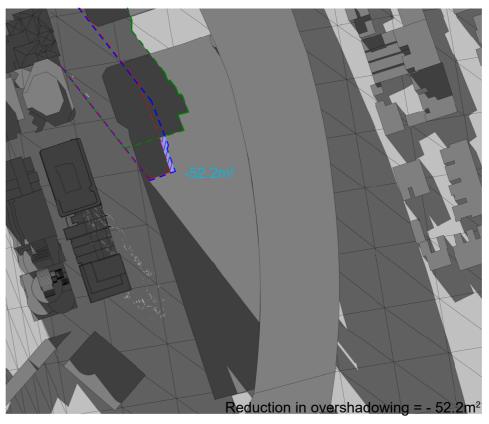


21st JUNE, 2.30 PM DETAILED SHADOW STUDY IN DETAIL

21st JUNE, 3 PM DETAILED SHADOW STUDY IN DETAIL


Existing Building Shadow - - -

- Proposed Building Shadow \_ \_
- North Neighbouring Shadow \_ \_ \_

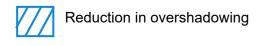


52 ALFRED STREET MILSONS POINT

PLANNING PROPOSAL FEBRUARY 2023

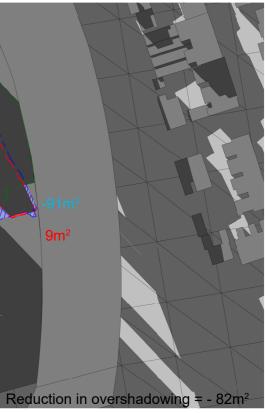




APPENDIX: ARCHITECTURAL DRAWINGS

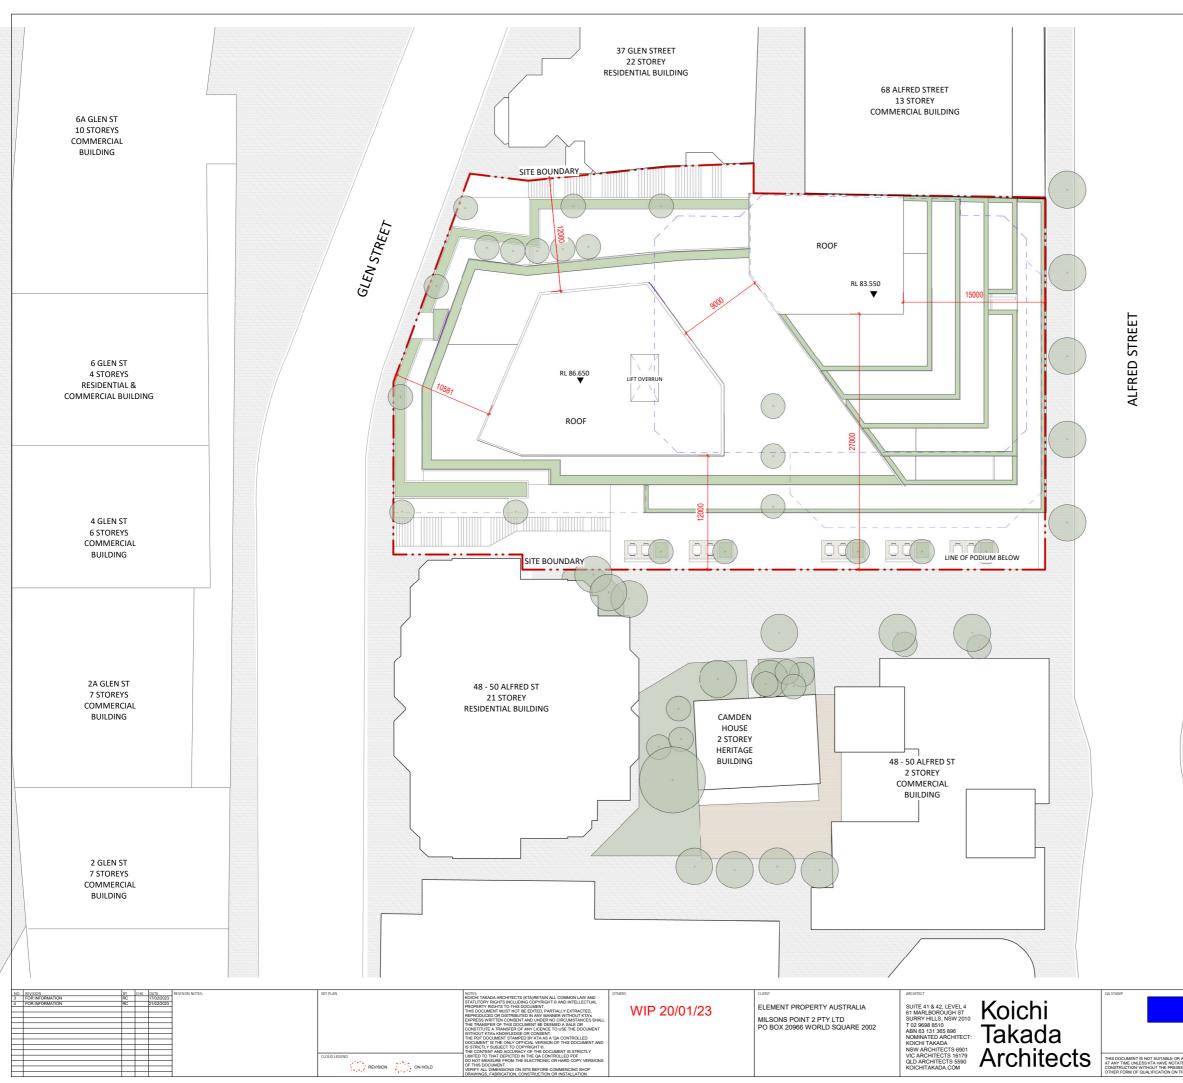


BOWLING GREEN
BOWLING GREEN

#### FITZROY STREET


	PRDIECT 52 Alfred St MILSONS POINT, NSW 2061	DWG THE SITE PLAN	
	STATUS	DWG NO.	REVISION
	PLANNING	A-0094	4
PPROVED FOR CONSTRUCTION D THE STATUS TITLE AS 'FOR CE OF 'WIP', 'DRAFT' OR ANY E DOCUMENT.	0 5 m	scale 1:100@A1, 1:200@A3	DATE 21/02/2023

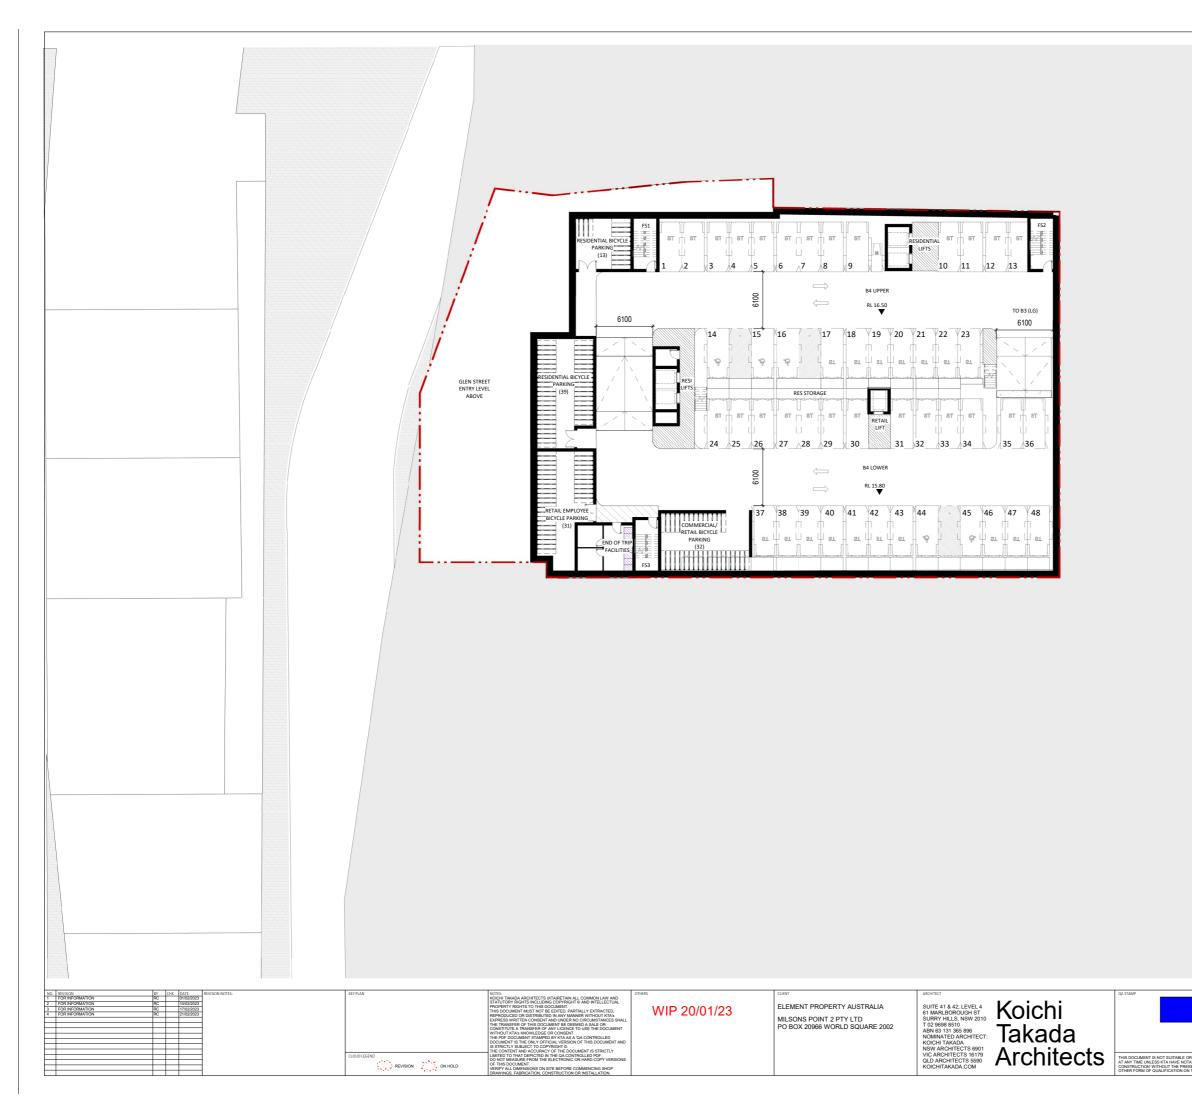


	PROJECT 52 Alfred St MILSONS POINT, NSW 2061	DWG TITLE BASEMENT 04	
	status PLANNING	DWG NO. A-0095	4
E OR APPROVED FOR CONSTRUCTION NOTATED THE STATUS TITLE AS FOR RESENCE OF WIP, 'DRAFT' OR ANY ON THE DOCUMENT.	05m	scale 1:100@A1, 1:200@A3	DATE 21/02/2023

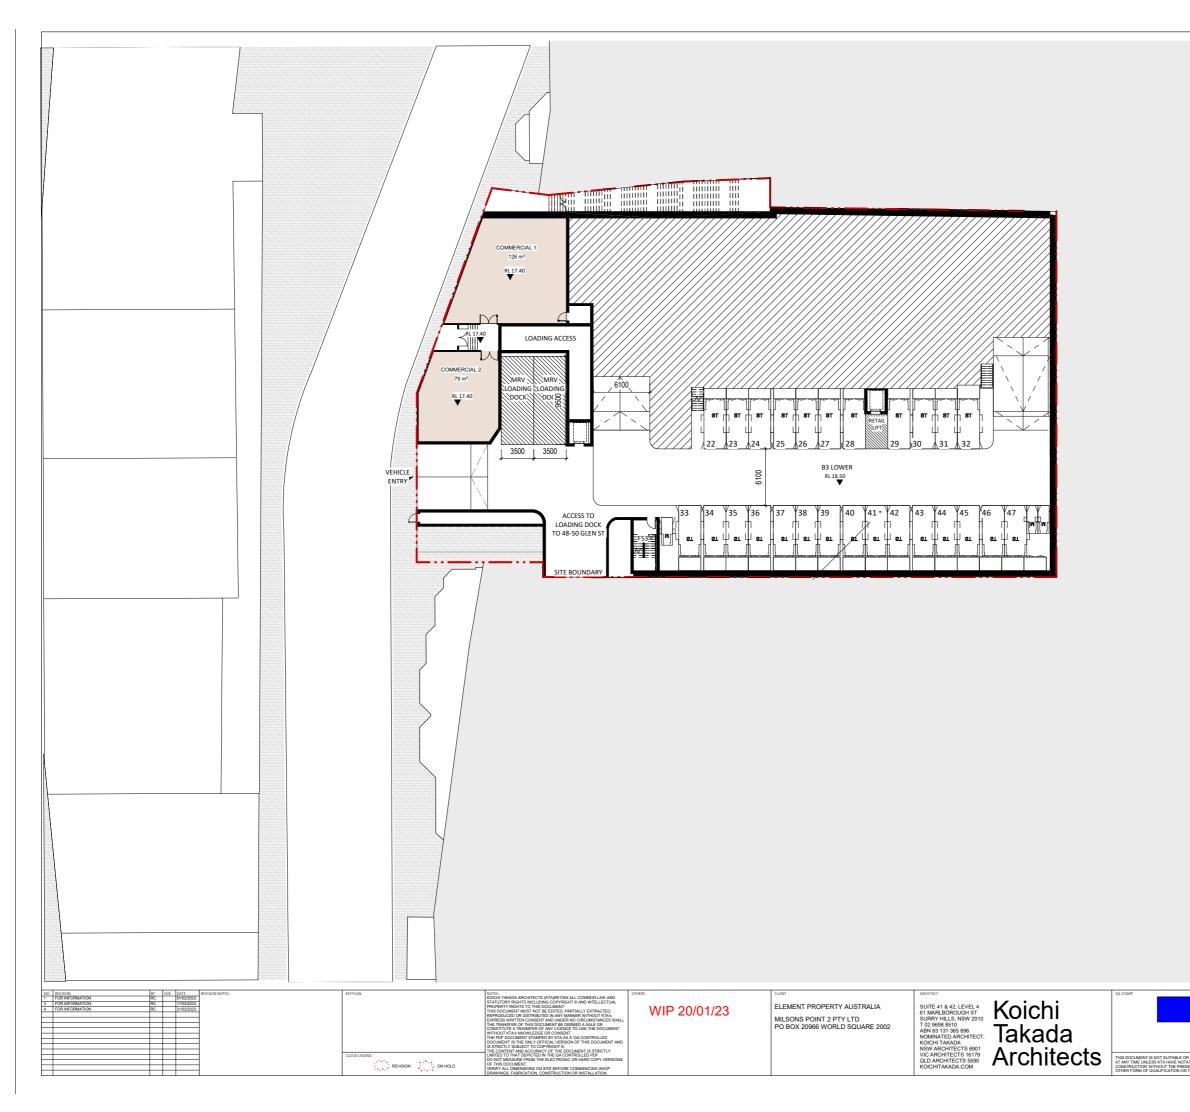

	PROJECT 52 Alfred St MILSONS POINT, NSW 2061	DWG TITLE BASEMENT 03 LOWER GROUNE	)
	PLANNING	DWG NO. A-0096	4
LE OR APPROVED FOR CONSTRUCTION NOTATED THE STATUS TITLE AS FOR PRESENCE OF WIP, 'DRAFT' OR ANY N ON THE DOCUMENT.	0 5m 🔿	scale 1:100@A1, 1:200@A3	DATE 21/02/2023

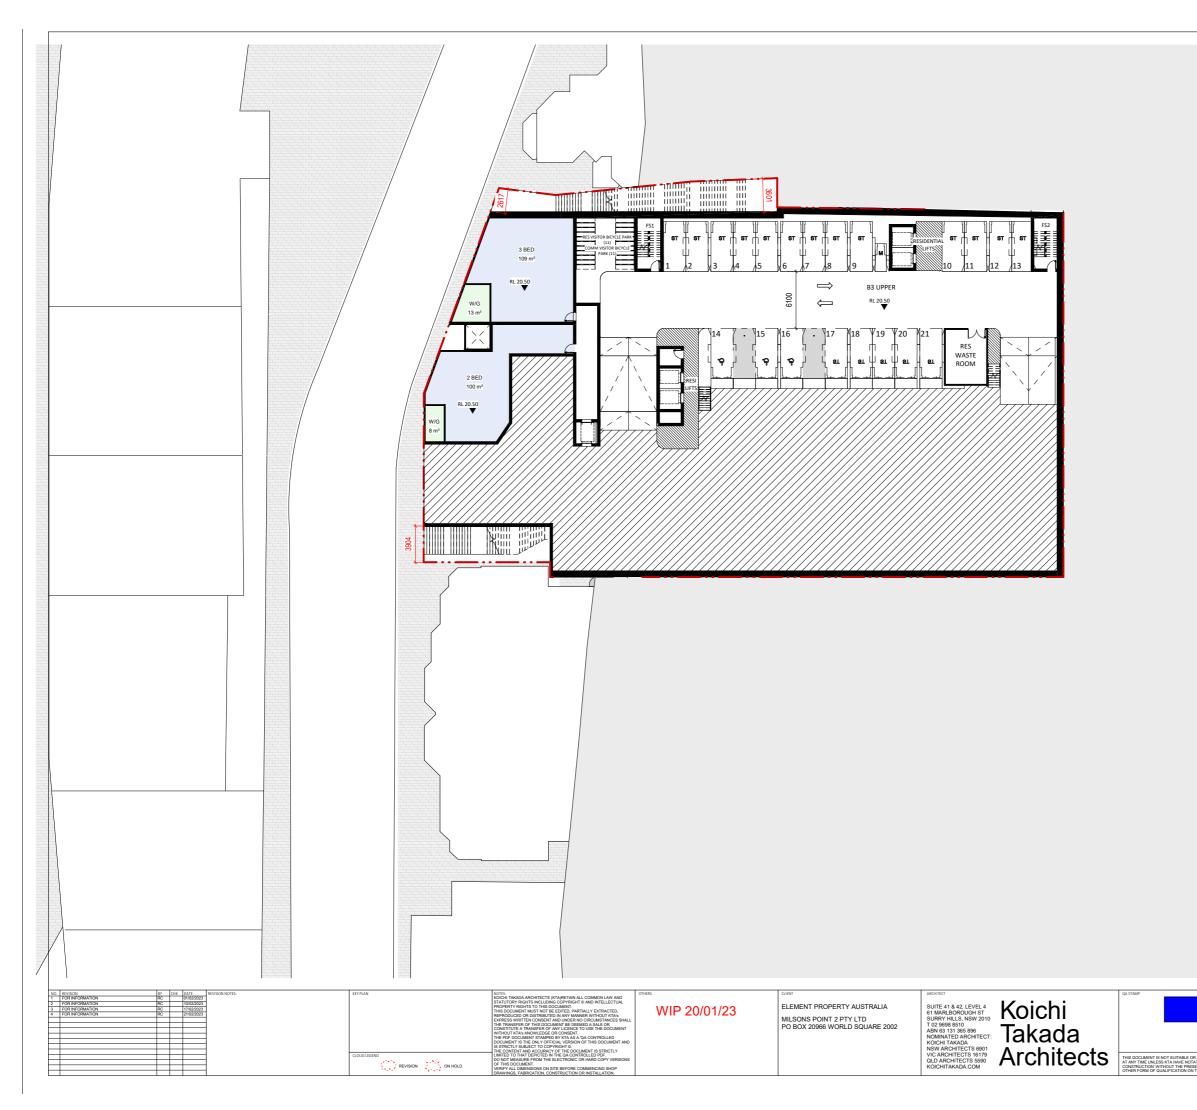


	PROJECT 52 Alfred St MILSONS POINT, NSW 2061	DWG TITLE BASEMENT 03	
	STATUS PLANNING	DWG NO. A-0097	revision 4
E OR APPROVED FOR CONSTRUCTION NOTATED THE STATUS TITLE AS FOR RESENCE OF WIP, 'DRAFT' OR ANY ON THE DOCUMENT.	0 5m	scale 1:100@A1, 1:200@A3	DATE 21/02/2023

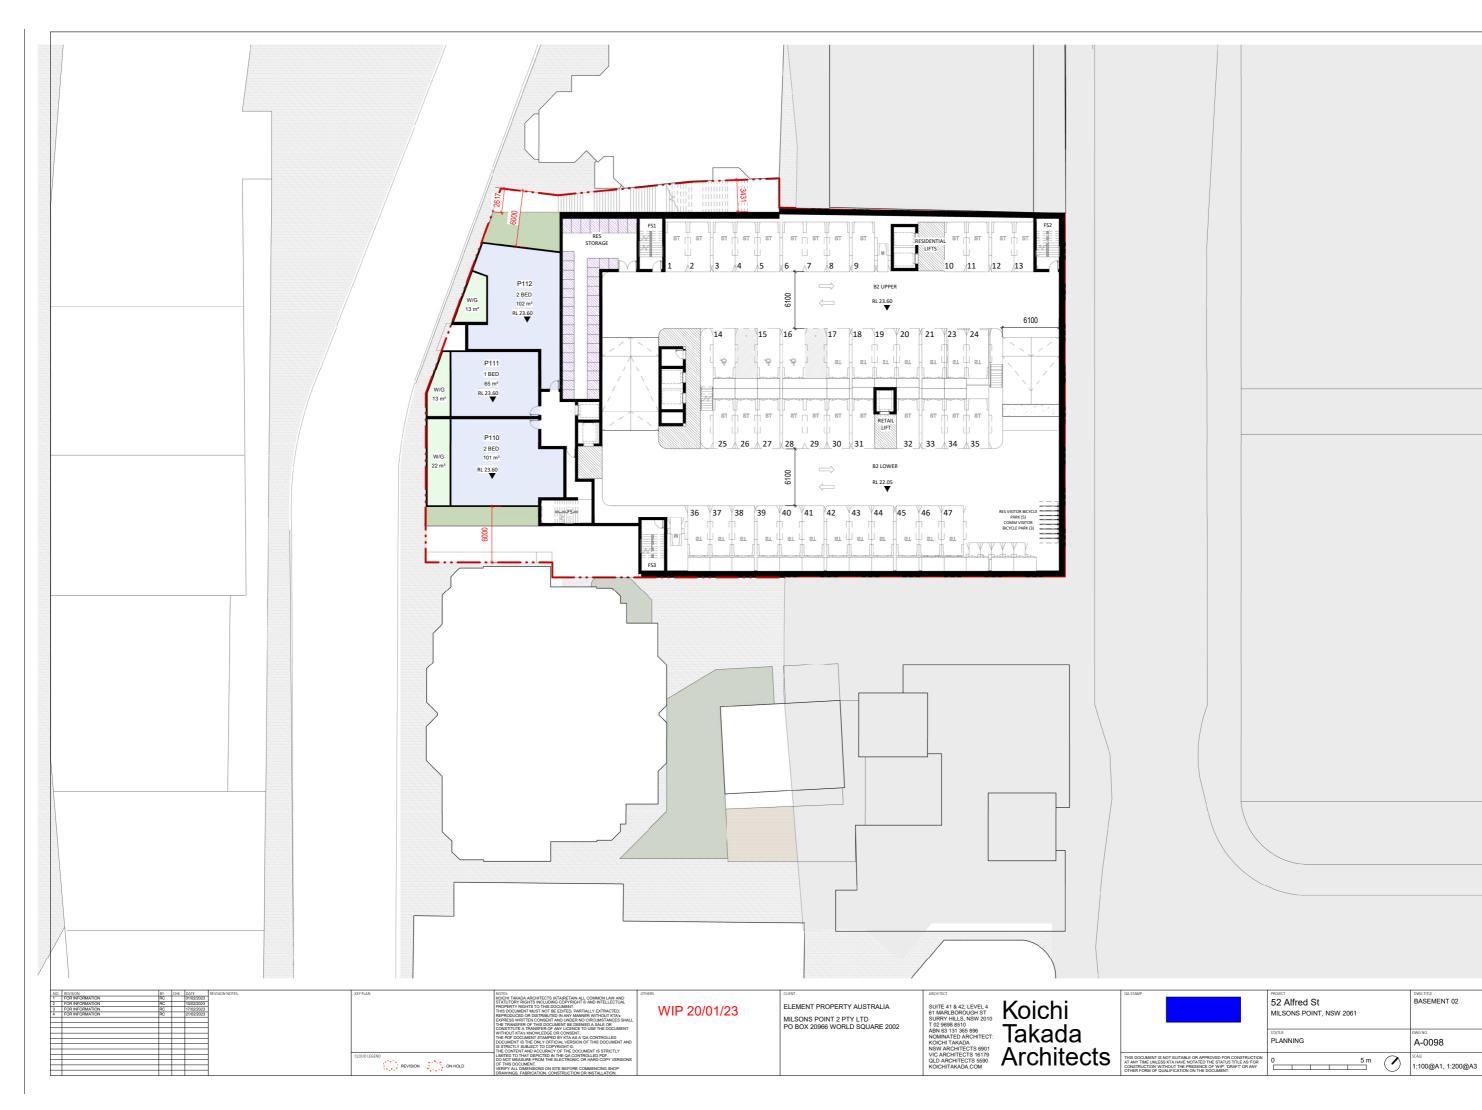


PROJECT 52 Alfred St MILSONS POINT, NSW 2061 STATUS PLANNING	риктите BASEMENT 02 Омено A-0098	REVISION 4

21/02/2023

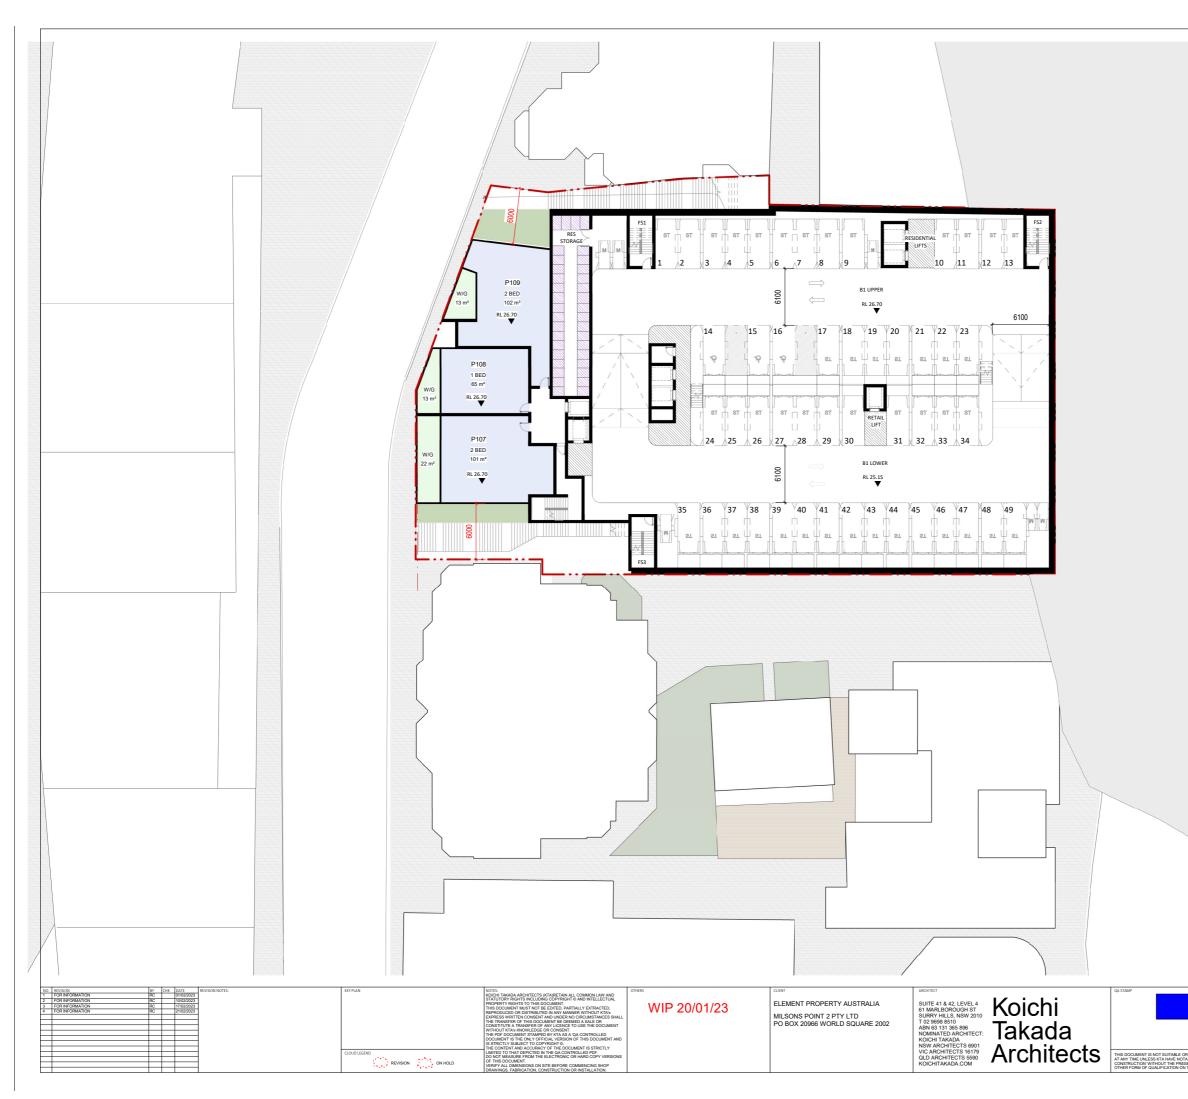


	PROJECT 52 Alfred St MILSONS POINT, NSW 2061	DWGTITLE BASEMENT 01	
	STATUS PLANNING	dwg no. A-0099	REVISION 4
E OR APPROVED FOR CONSTRUCTION NOTATED THE STATUS TITLE AS FOR RESENCE OF WIP, 'DRAFT' OR ANY ON THE DOCUMENT.	05m		DATE 21/02/2023

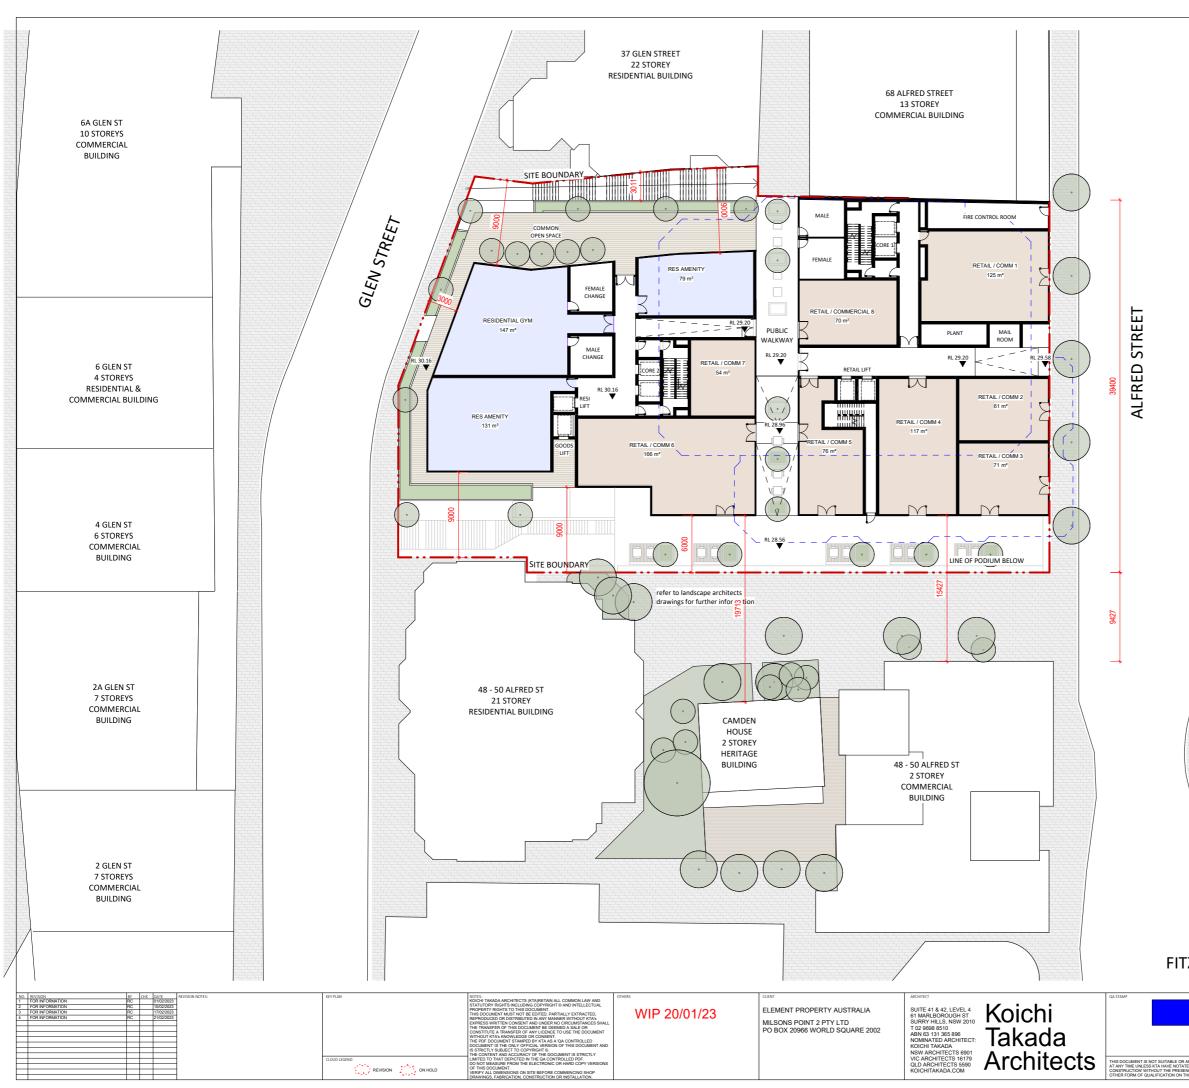

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BOWLING GREEN

# FITZROY STREET


PROJECT		DWG TITLE	
52 Alfred St		GROUND FLOOR	
MILSONS POINT, NSW 2001			
STATUS		DWG ND.	REVISION
PLANNING		A-0100	4
		SCALE	DATE
0 5 m (	$\bigcirc$	1:100@A1, 1:200@A3	21/02/2023
	52 Alfred St MILSONS POINT, NSW 2061	52 Alfred St MILSONS POINT, NSW 2061 STATUS PLANNING 0 5 m	52 Alfred St     GROUND FLOOR       MILSONS POINT, NSW 2061     DWG NO.       PLANNING     A-0100

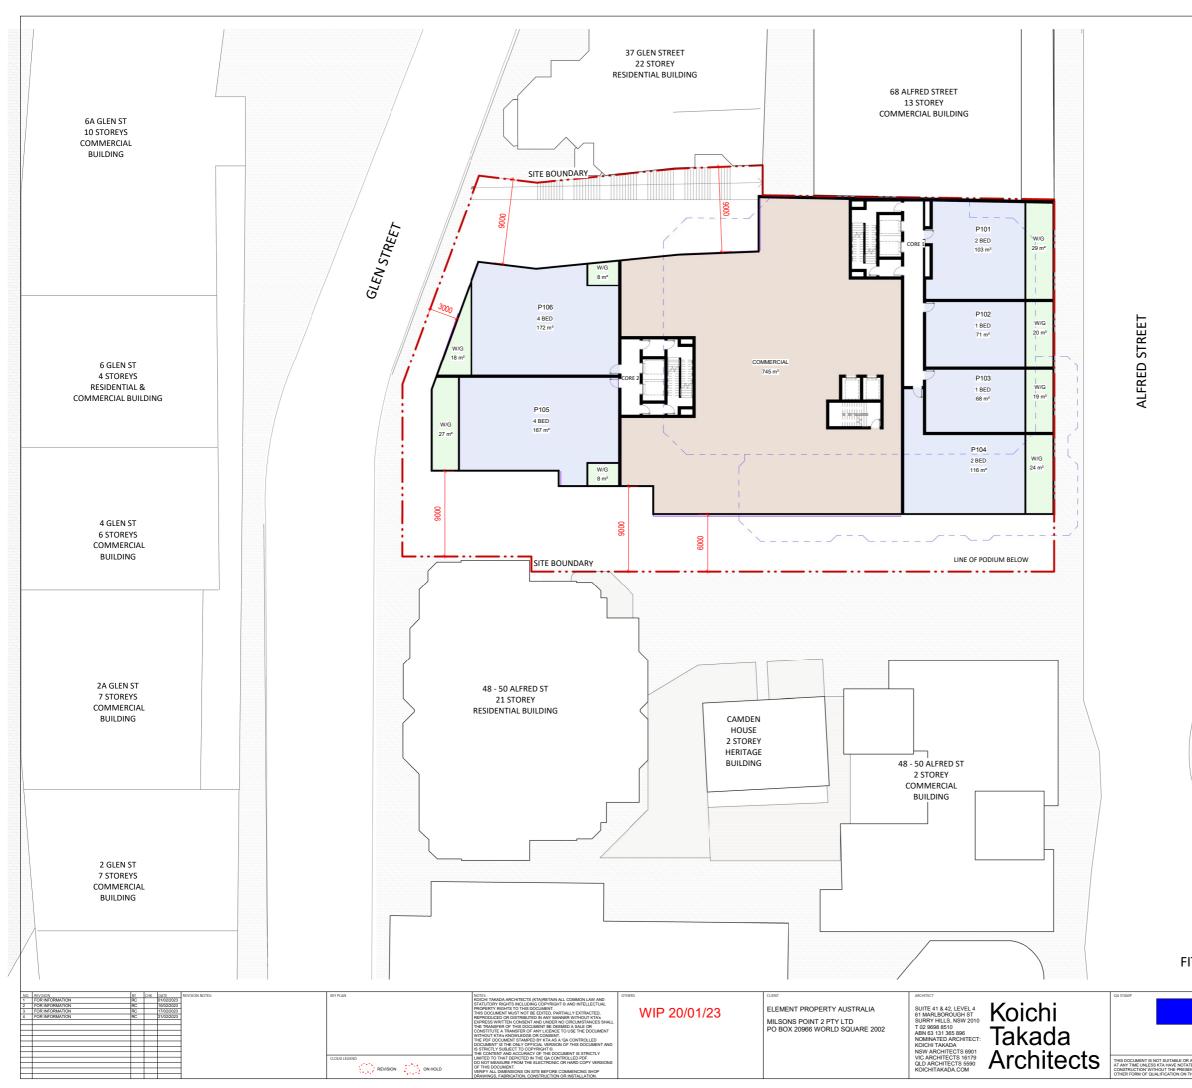

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#### FITZROY STREET


	PRIMET 52 Alfred St MILSONS POINT, NSW 2061	DWGTITLE LEVEL 01	
	PLANNING	A-0101	4
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	BOWLING GREEN	

## FITZROY STREET

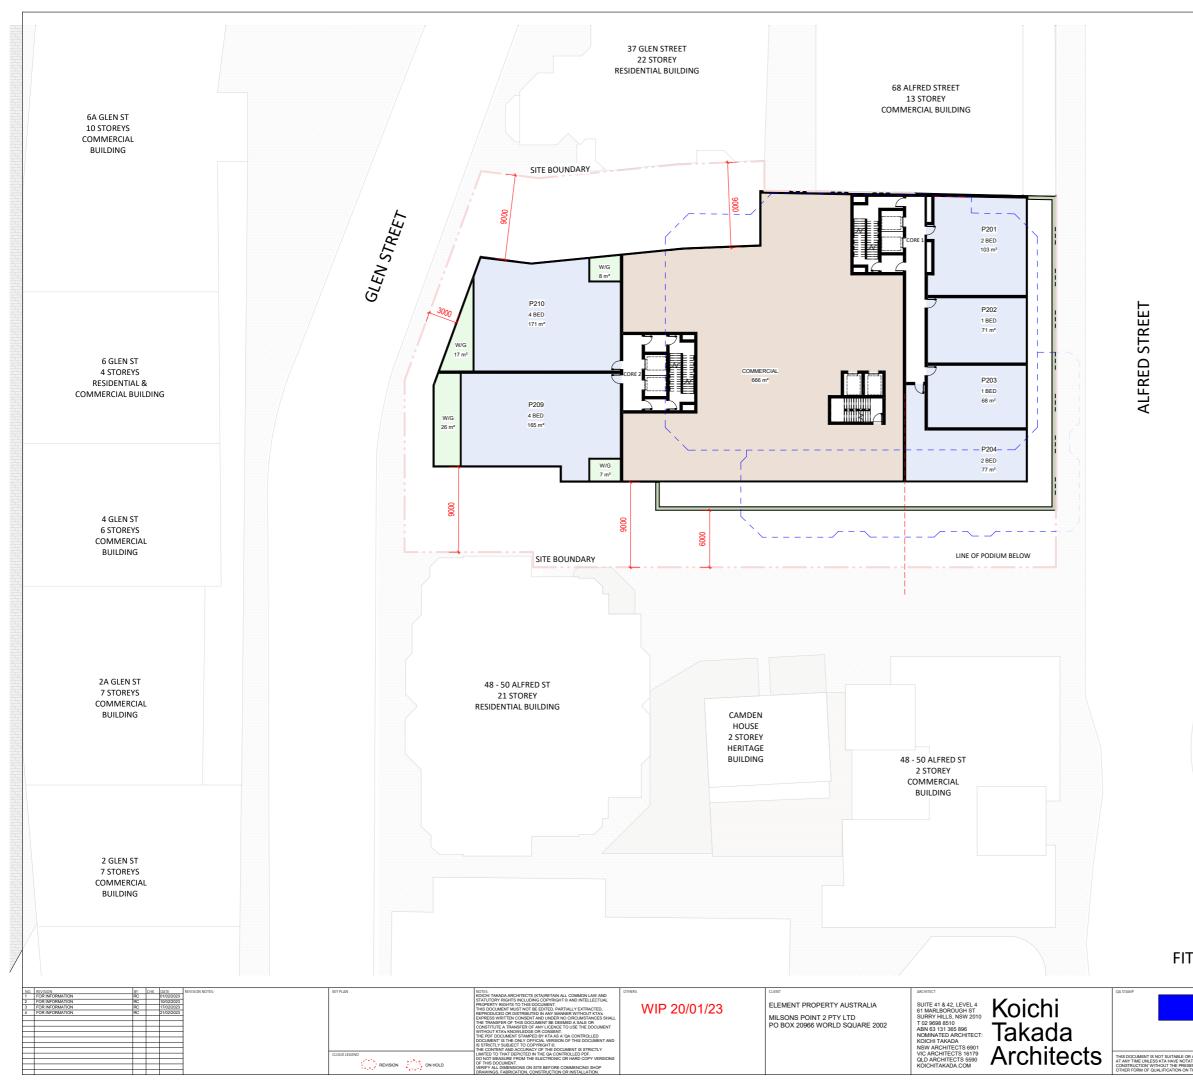	PRDRET 52 Alfred St MILSONS POINT, NSW 2061		DWG TITLE LEVEL 02	
	STATUS PLANNING		A-0102	4
APPROVED FOR CONSTRUCTION TED THE STATUS TITLE AS 'FOR ENCE OF 'WIP', 'DRAFT' OR ANY THE DOCUMENT.	05m (	\	scale 1:100@A1, 1:200@A3	DATE 21/02/2023



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	PROJECT 52 Alfred St MILSONS POINT, NSW 2061		DWG TITLE LEVEL 03	
	STATUS		DWG NO.	REVISION
	PLANNING		A-0103	4
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	PROJECT 52 Alfred St MILSONS POINT, NSW 2061	TYPICAL PLAN L04 - 07	
	PLANNING	DWG NO. A-0104	REVISION 4
PROVED FOR CONSTRUCTION THE STATUS TITLE AS 'FOR E OF WIP', 'DRAFT' OR ANY DOCUMENT.	05m (	) SCALE 1:100@A1, 1:200@A3	DATE 21/02/2023

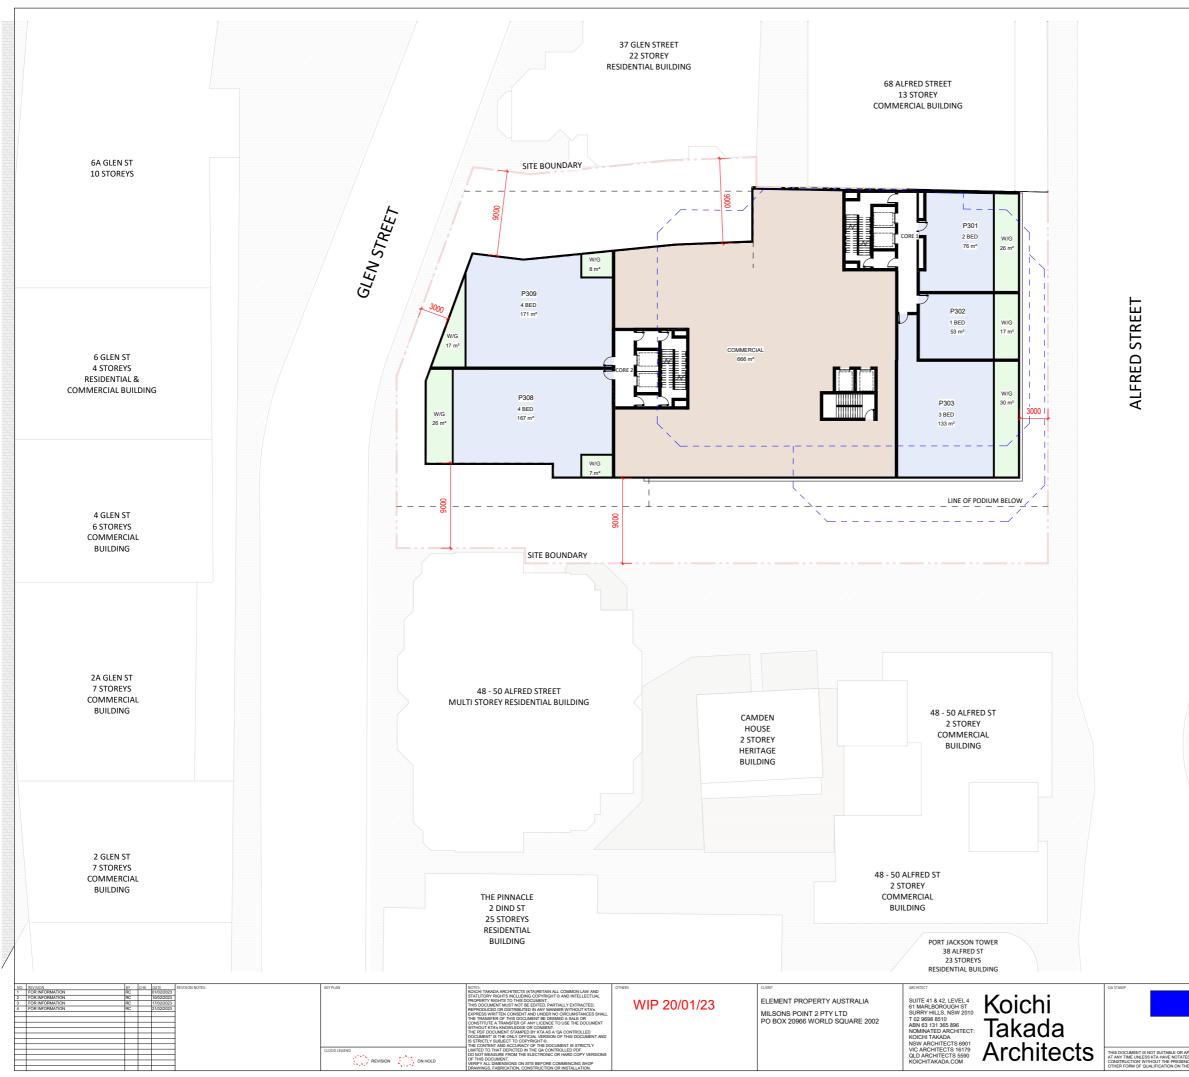

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	52 Alfred St MILSONS POINT, NSW 2061		DWGTITLE LEVEL 08	
	STATUS		DWG NO.	REVISION
	PLANNING		A-0108	4
PROVED FOR CONSTRUCTION 1 THE STATUS TITLE AS 'FOR E OF 'WIP', 'DRAFT' OR ANY DOCUMENT.	0 5 m	$(\Lambda)$	scale 1:100@A1, 1:200@A3	DATE 21/02/2023




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PRDECT DWG TITLE

	52 Alfred St MILSONS POINT, NSW 2061	LEVEL 09	
			REVISION
	PLANNING	A-0109	4
ROVED FOR CONSTRUCTION HE STATUS TITLE AS 'FOR OF 'WIP', 'DRAFT' OR ANY OCUMENT.	0 5m 🔿	scale 1:100@A1, 1:200@A3	DATE 21/02/2023



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	BOWLING GREEN	
 PROJECT		

	52 Alfred St MILSONS POINT, NSW 2061		DWG TITLE TYPICAL PLAN L10-12	
	STATUS		DWG NO.	REVISION
	PLANNING		A-0110	4
PROVED FOR CONSTRUCTION O THE STATUS TITLE AS 'FOR 2E OF 'WIP', 'DRAFT' OR ANY E DOCUMENT.	0 5 m	$(\Lambda)$	scale 1:100@A1, 1:200@A3	DATE 21/02/2023

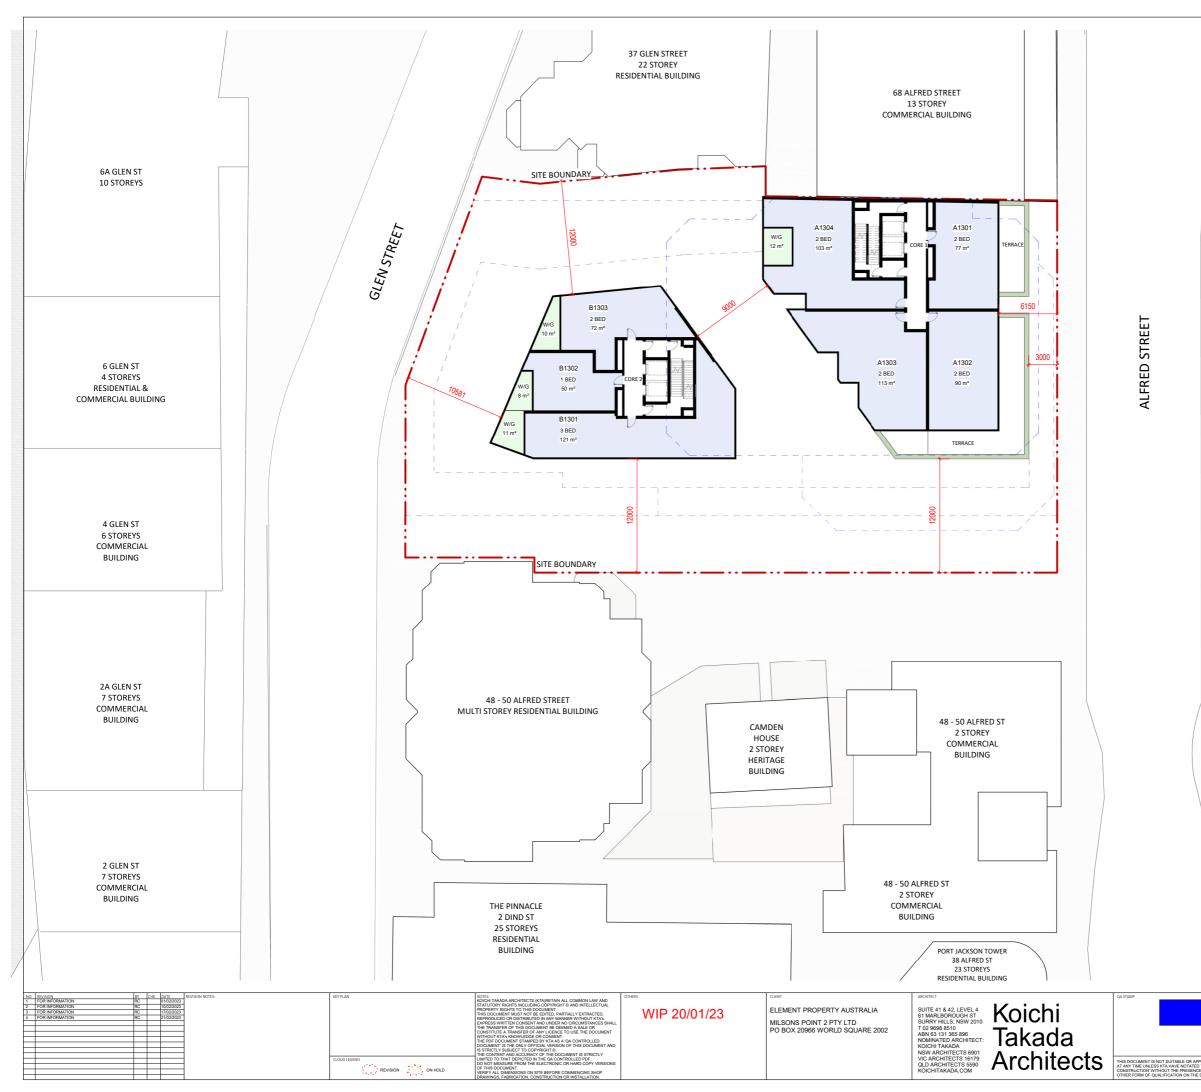


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PROJECT 52 Alfred St MLSONS POINT, NSW 2061

	52 Alfred St MILSONS POINT, NSW 2061	LEVEL 13	
	STATUS	DWG NO.	REVISION
	PLANNING	A-0113	4
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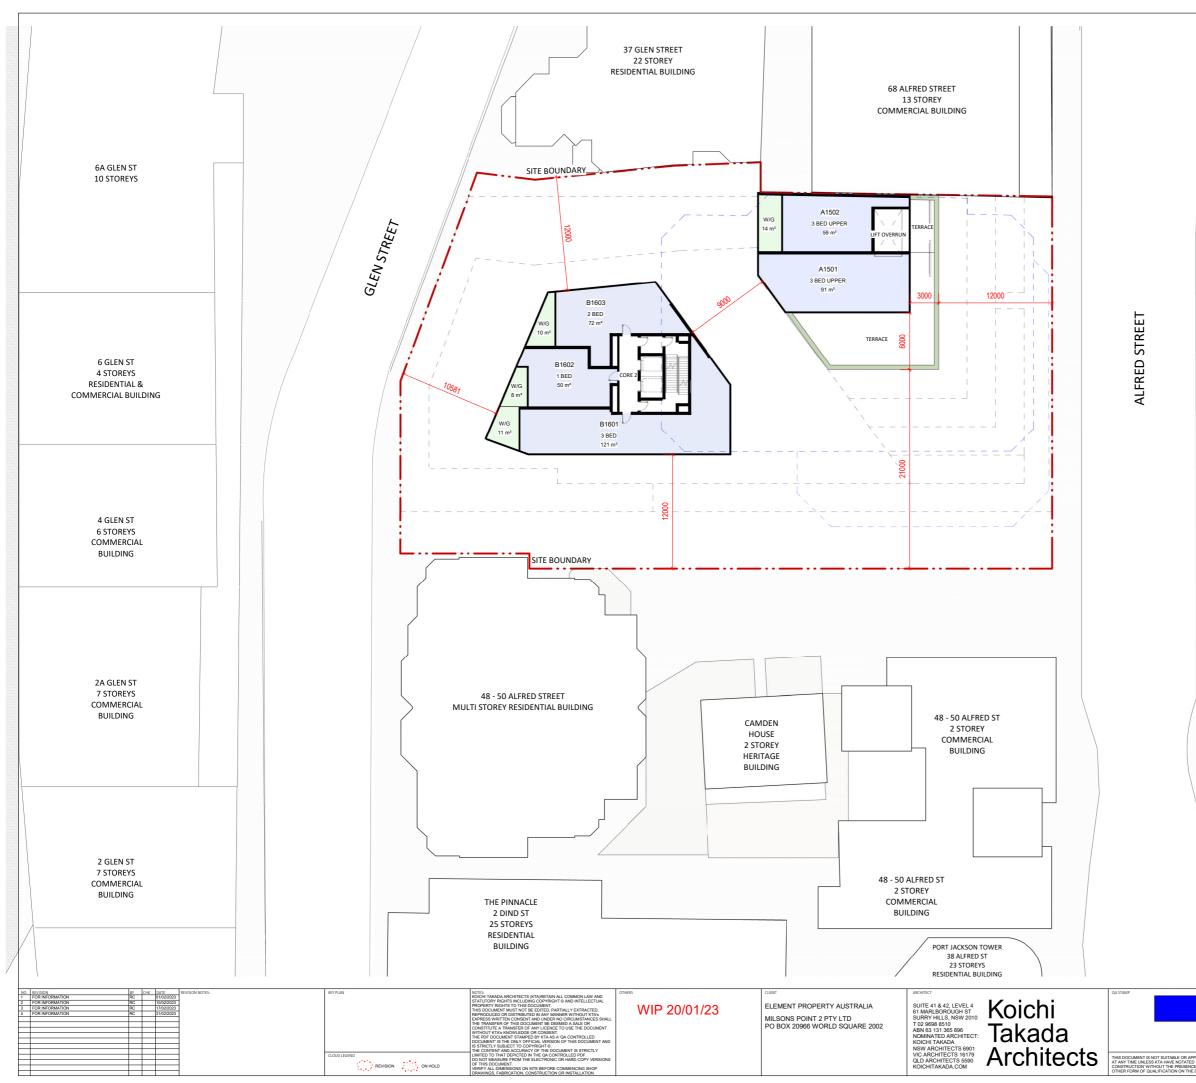
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	PROJECT 52 Alfred St MILSONS POINT, NSW 2061	DWG TITLE LEVEL 14	
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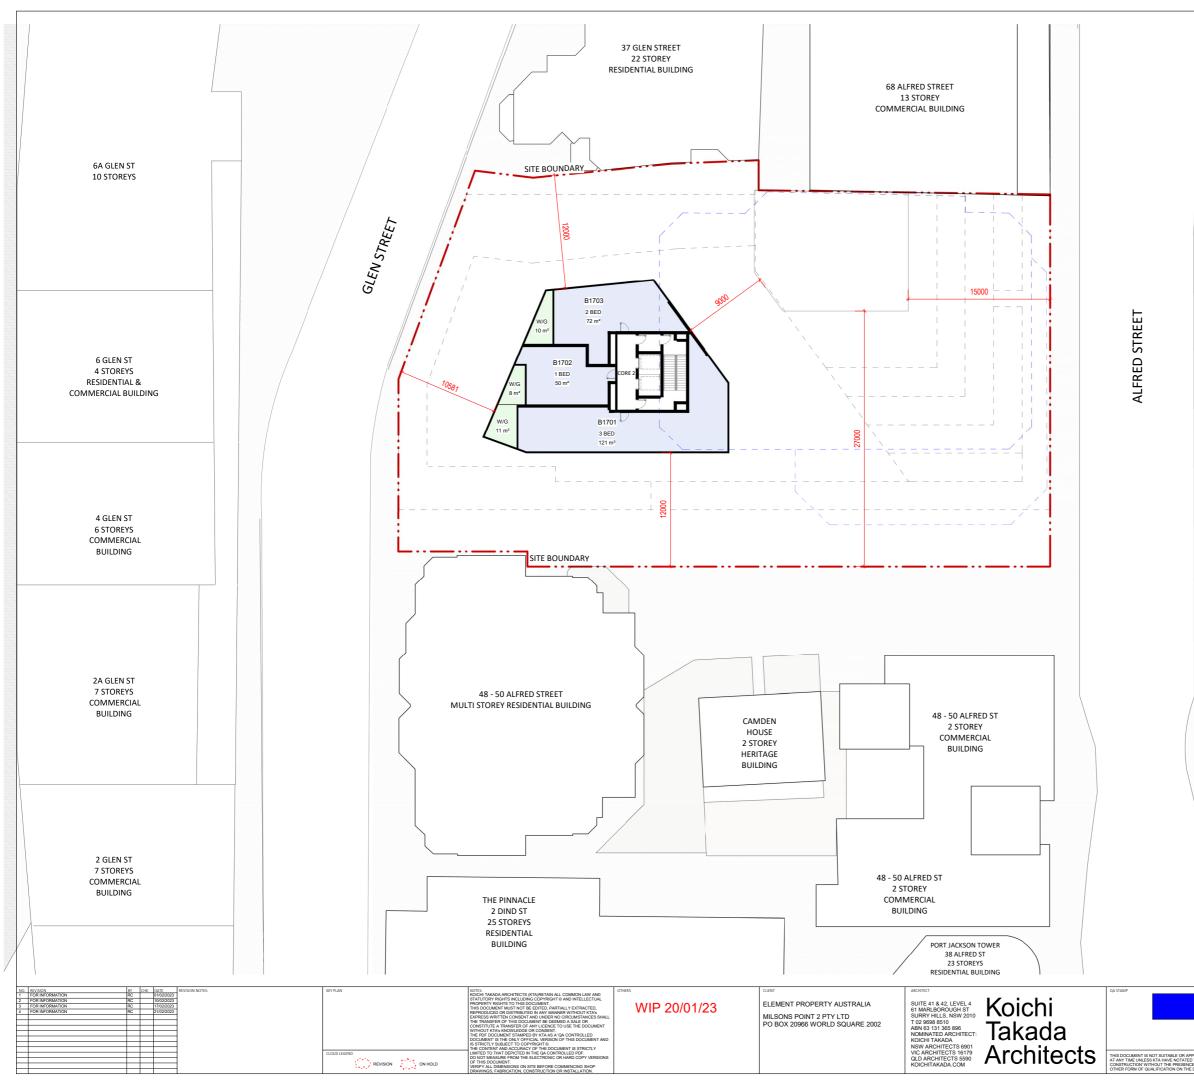
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PROJECT 52 Alfred St MLISONS POINT, NSW 2061

	MILSONS POINT, NSW 2061		
	STATUS	DWG NO.	REVISION
	PLANNING	A-0115	4
/ED FOR CONSTRUCTION STATUS TITLE AS 'FOR 'WIP', 'DRAFT' OR ANY UMENT.	0 5m ( 🖊	scale 1:100@A1, 1:200@A3	DATE 21/02/2023




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PROJECT 52 Alfred St MLISONS POINT, NSW 2061

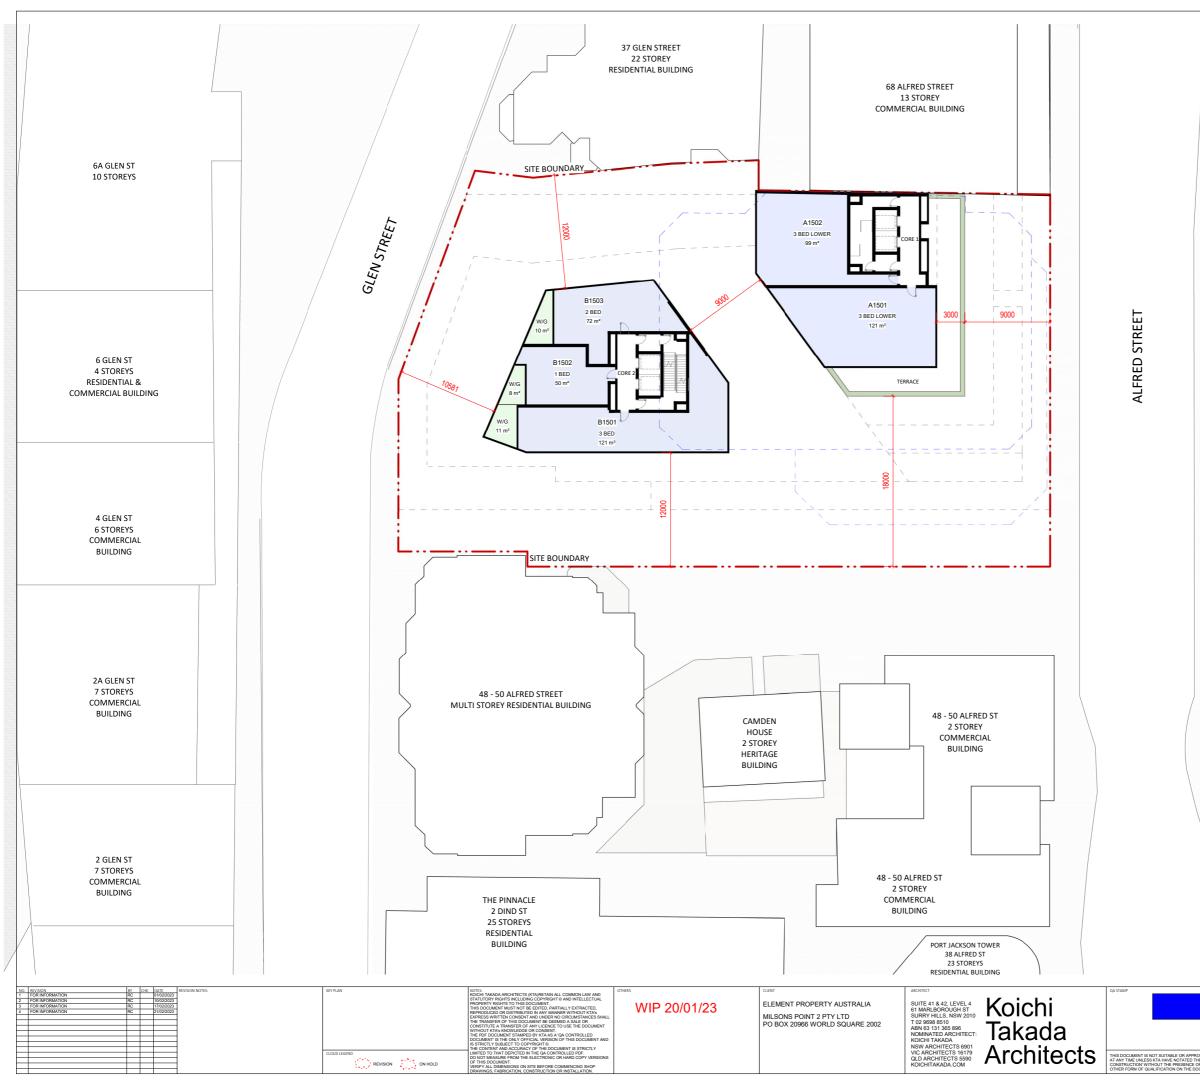	52 Alfred St MILSONS POINT, NSW 2061	LEVEL 16	
	STATUS	DWG NO.	REVISION
	PLANNING	A-0116	4
ROVED FOR CONSTRUCTION THE STATUS TITLE AS 'FOR OF 'WIP', 'DRAFT' OR ANY OCUMENT.	0 5m 🔿	scale 1:100@A1, 1:200@A3	DATE 21/02/2023



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	52 Alfred St MILSONS POINT, NSW 2061	LEVEL 17	
	PLANNING	DWG NO. A-0117	revision 4
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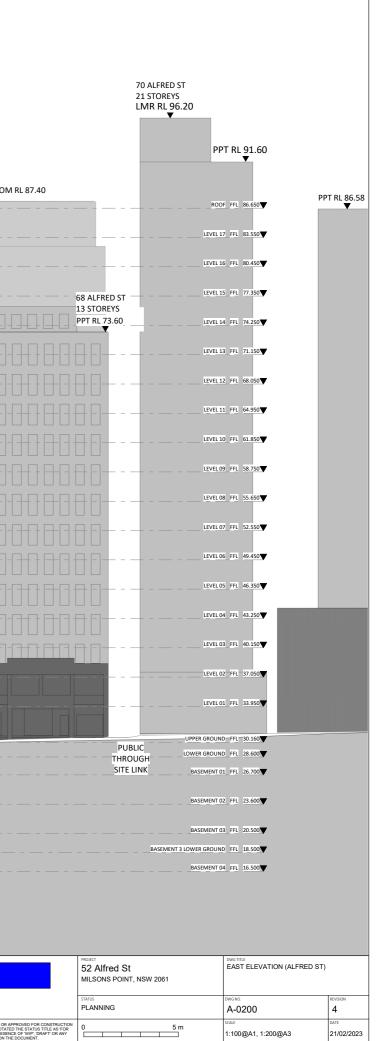



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#### FITZROY STREET

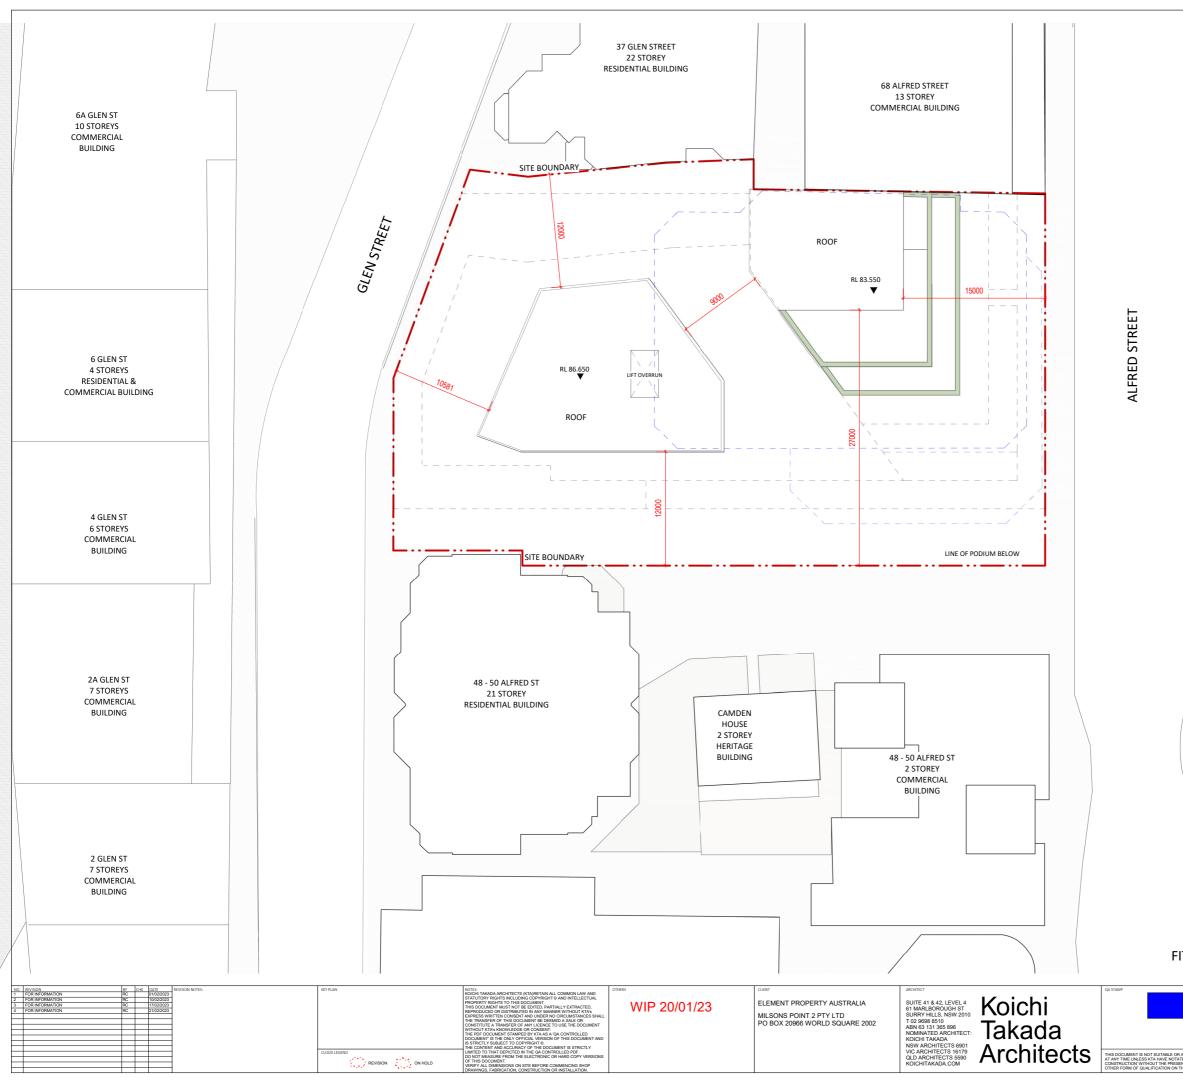
	52 Alfred St MILSONS POINT, NSW 2061		DWG TITLE ROOF PLAN	
	STATUS PLANNING		DWG NO. A-0118	REVISION 4
APPROVED FOR CONSTRUCTION TED THE STATUS TITLE AS 'FOR ENCE OF 'WIP', 'DRAFT' OR ANY THE DOCUMENT.	0 5 m	$(\Lambda)$	scale 1:100@A1, 1:200@A3	DATE 21/02/2023

				TOP OF PAR RL 87.10	AUPET BUILDING A OF BUILDING 33.55 RL 83.75	37 GLEN ST 22 STOREYS LIFT MACHINE ROOM
NO BEVICION T FORMEDINATION BY CIN DATE T FORMEDINATION RECOMMENDINATION T FORMEDINATION T FORMEDINATION	NOTE: NOTE: NOTE: STATUTORY BORTS INCLUDING COPYING AND	oness WIP 20/01/23	CLEAT ELEMENT PROPERTY AUSTRALIA MILSONS POINT 2 PTY LTD PO BOX 20966 WORLD SQUARE 2002	ACCHIECT SUTTECT SUTTECT SURPRY-INLIGN.NGH ST SURPRY-INLIGN.NGH ST SURPRY-INLIGN.SURPRY-INLIGN.SURPRY-INLIGN.SURPRY-INLIGN.SURPRY-INLIGN.SURPRY-INLIGN.SURPRY-INLIGN.SURPRY-INLIGN.SURPRY-INLIGN.SURPRY-INLIGN.SURPRY-INLIGN.SURPRY-INLIGN.SURPRY-INLIGN.SURPRY-INLIGN.SURPRY-INLIGN.SURPRY-INLIGN.SURPRY-INLIGN.SURPRY-INLIGN.SURPRY-INLIGN.SURPRY-INLIGN.SURPRY-INLIGN.SURPRY-INLIGN.SURPRY-INLIGN.SURPRY-INLIGN.SURPRY-INLIGN.SURPRY-INLIGN.SURPRY-INLIGN.SURPRY-INLIGN.SURPRY-INLIGN.SURPRY-INLIGN.SURPRY-INLIGN.SURPRY-INLIGN.SURPRY-INLIGN.SURPRY-INLIGN.SURPRY-INLIGN.SURPRY-INLIGN.SURPRY-INLIGN.SURPRY-INLIGN.SURPRY-INLIGN.SURPRY-INLIGN.SURPRY-INLIGN.SURPRY-INLIGN.SURPRY-INLIGN.SURPRY-INLIGN.SURPRY-INLIGN.SURPRY-INLIGN.SURPRY-INLIGN.SURPRY-INLIGN.SURPRY-INLIGN.SURPRY-INLIGN.SURPRY-INLIGN.SURPRY-INLIGN.SURPRY-INLIG	oichi akada	




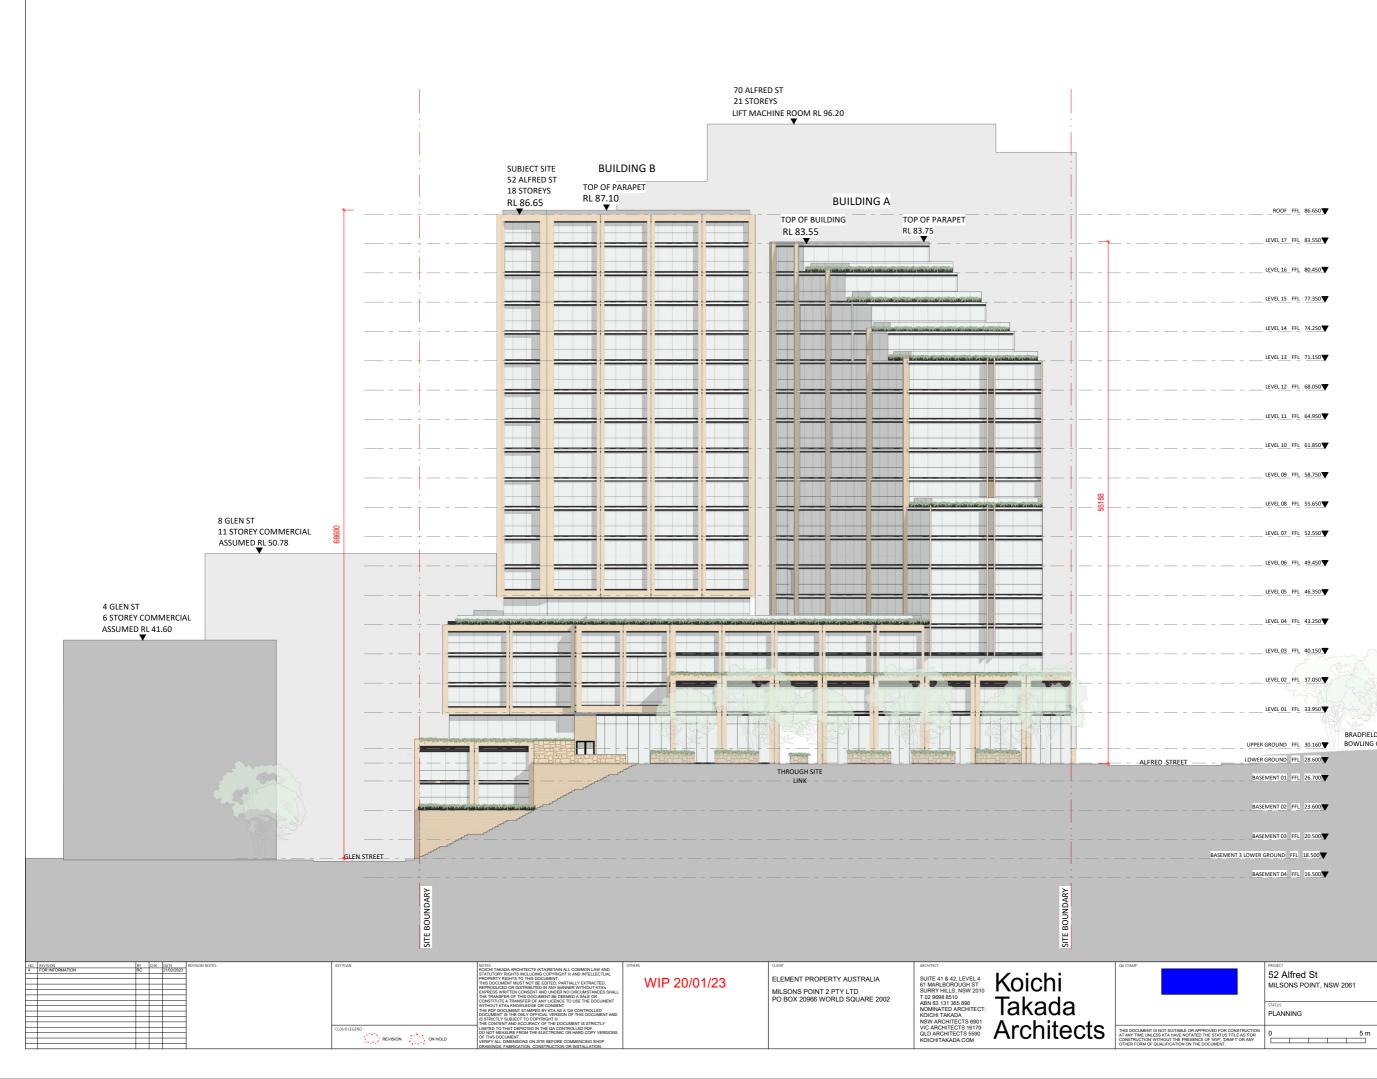


	_ROOF_FFL	86 650			
	LEVEL 17 FFL				
	LEVEL 16 FFL	80.450			
	LEVEL 15_FFL	77.350			
	LEVEL 14 FFL	74.250			
	LEVEL 13 FFL	71.150			
	LEVEL 12 FFL	68.050			
	LEVEL 11_FFL	64.950			
	LEVEL 10 FFL	61.850			
	LEVEL 09 FFL	58.750			
	LEVEL 08_FFL	55.650			
	LEVEL 07 FFL	52.550			
	LEVEL 06 FFL	49.450			
	LEVEL 05_FFL	46.350			
	LEVEL 04 FFL	43.250			
	LEVEL 03 FFL	40.150			
	LEVEL 02_FFL	37.050			
	LEVEL 01_FFL	33.950			
	GROUND_FFL		ADFIELD PARK WLING GREEN		
	GROUND FFL	1121			
BASE	MENT 01 FFL	26.700			
BASE	MENT 02 FFL	23.600			
BASE	MENT 03 FFL	20.500			
BASEMENT 3 LOWER 0					
BASE	MENT 04 FFL	16.500			
	PROJECT			DWG TITLE	
	52 Alfree MILSONS F	d St POINT, NSW 2061	1	SOUTH ELEVATION	
	status PLANNING			DWG NO. A-0201	REVISION 4
R APPROVED FOR CONSTRUCTION ATED THE STATUS TITLE AS FOR SENCE OF WIP, 'DRAFT' OR ANY THE DOCUMENT.	0		5 m	scale 1:100@A1, 1:200@A3	DATE 21/02/2023

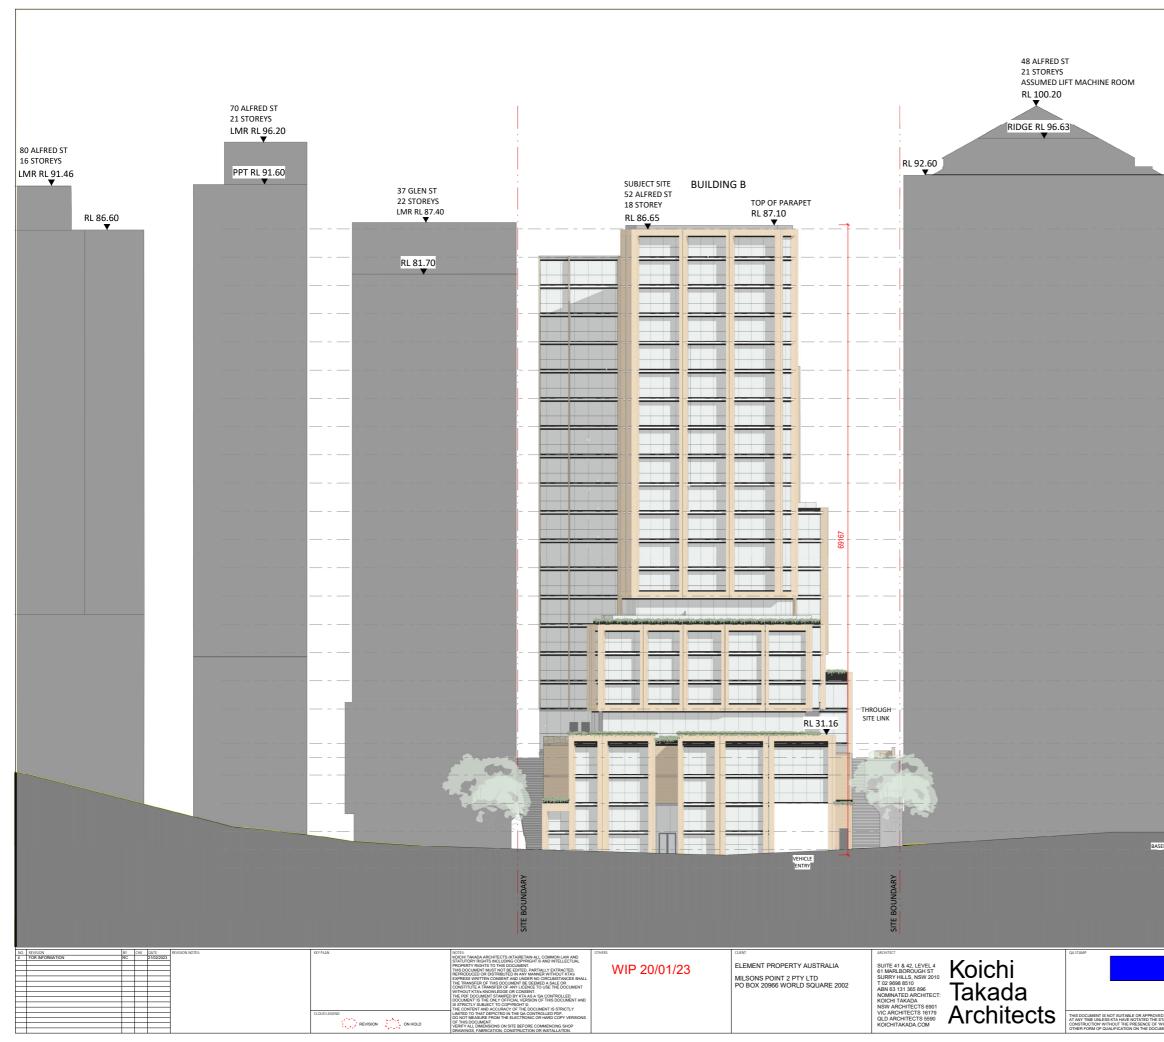


		2 DIND ST 26 STOREYS	
		RL 95.64	
	RL 90.49 ▼		
<sup>H</sup>	00F FFL 86.650		
LEVI	EL17 FFL 83.550		
L <u>E</u> V	EL 16 FFL 80.450		
L <u>E</u> VI	EL15 FFL 77.350		
	EL14 FFL 74.250		
	EL13 FFL 71.150		
	EL 12 FFL 68.050		
LEV	EL11 FFL 64.950		
	EL10 FFL 61.850▼		
L <u>E</u> VI	EL 09 FFL 58.750		
L <u>E</u> VI	EL 08 FFL 55.650		
	EL 07 FFL 52.550		
L <u>e</u> vi	EL 06 FFL 49.450		
	ELOS FFL 46.350		
L <u>E</u> V!	EL 04 FFL 43.250		
LEV	ELO3 FFL 40.150		
	EL 02 FFL 37.050		
LEVI	EL01 FFL 33.950		
	UND FFL 30.160		
	UND FFL 28.600 TO1 FFL 26.700		
BASEMEN	IT 02 FFL 23.600		
	1703_FFL_20.500		
BASEMEN	1T 04 FFL 16.500		
	PROJECT 52 Alfred St MILSONS POINT, NSW 2061	DWG TITLE GLEN ST ELEVATION	
			REVISION 4

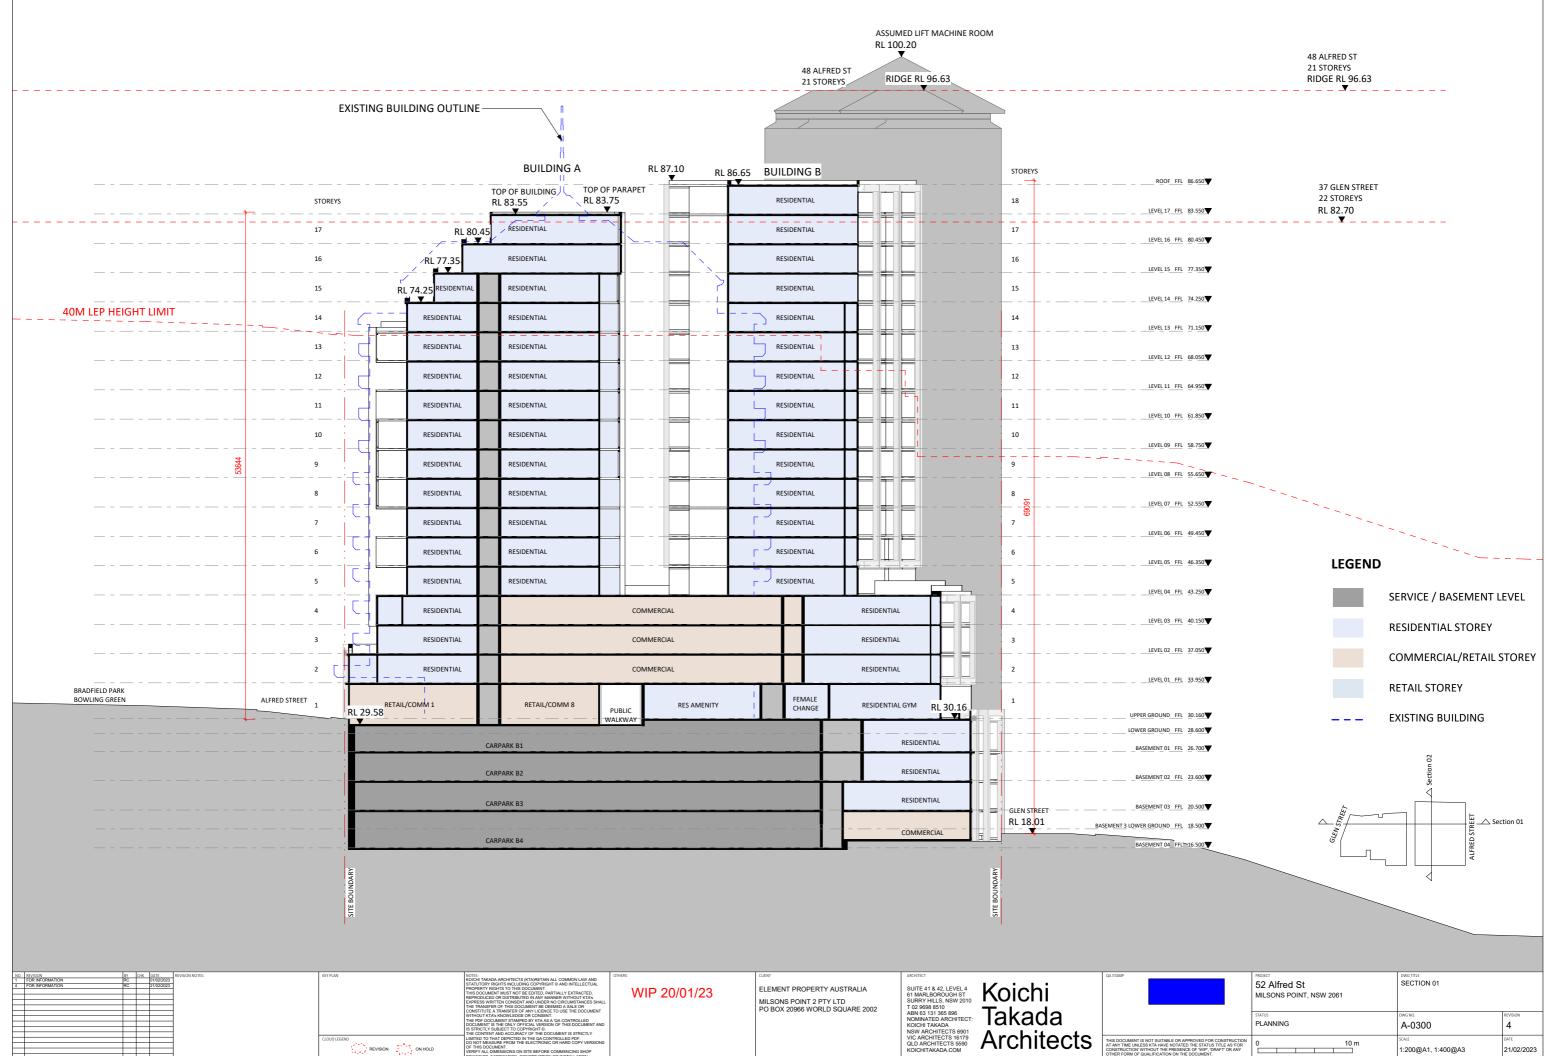


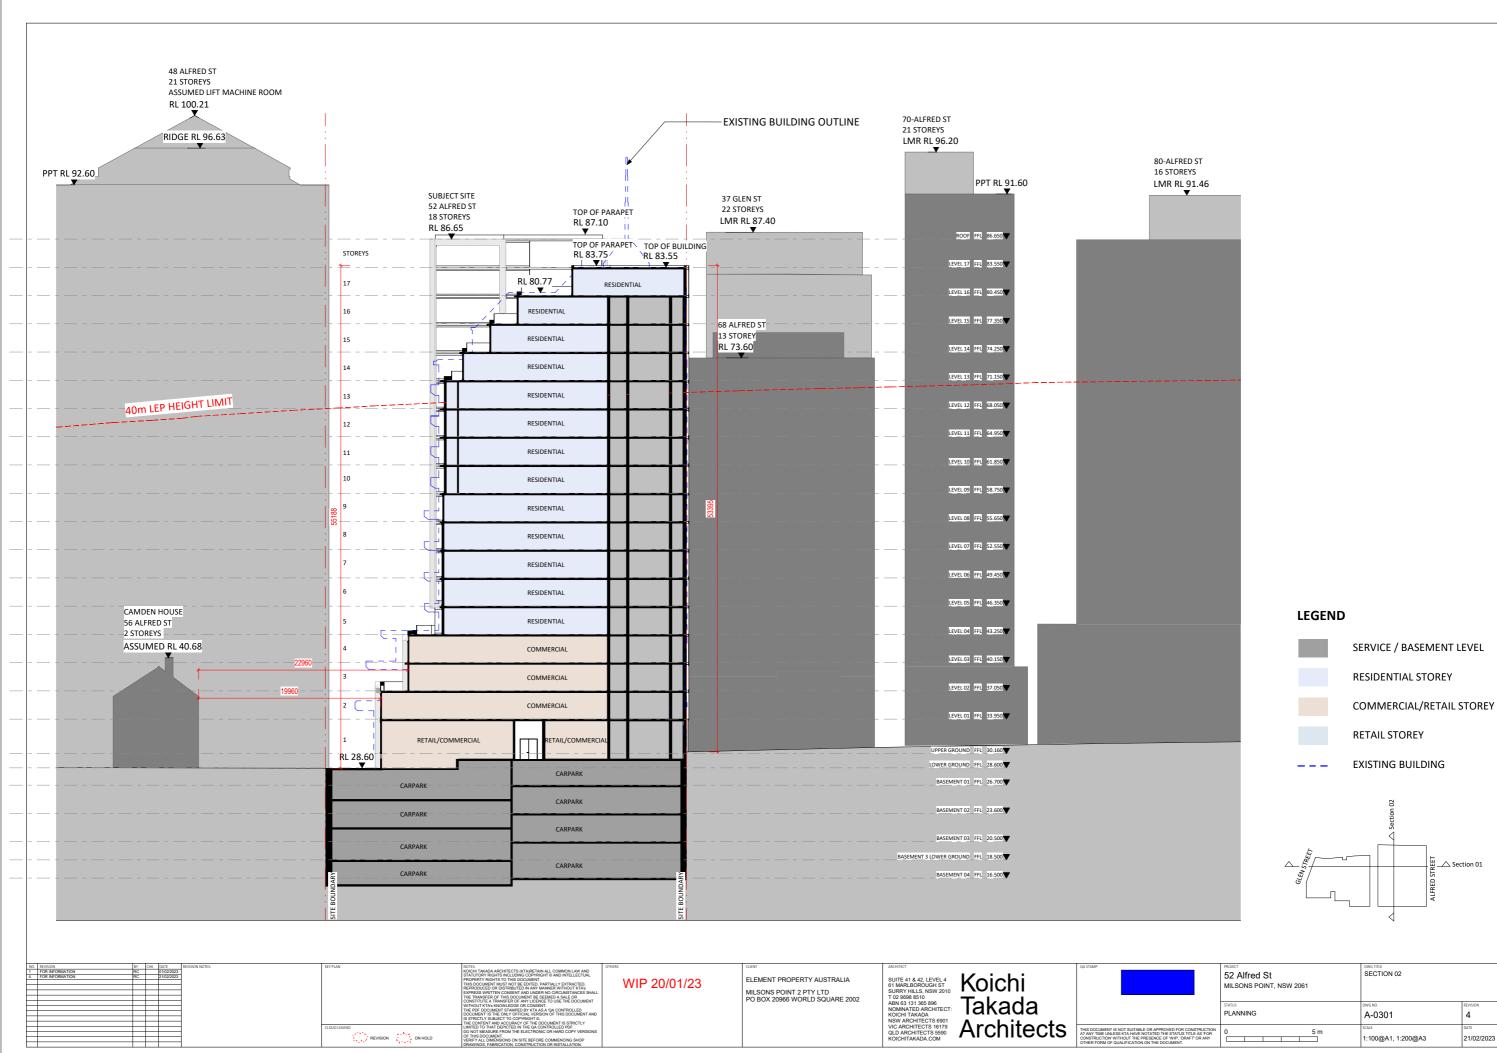


	PROJECT 52 Alfred St MILSONS POINT, NSW 2061	DWG TITLE SECTION 02	
	PLANNING	DWG NO. A-0301	4
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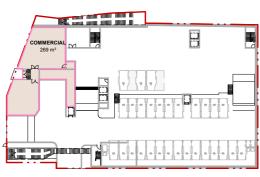
BASEMENT 04 GFA Copy 2

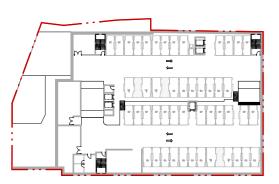


UPPER GROUND GFA Copy 2

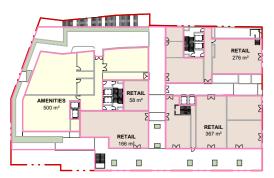


LEVEL 05 GFA Copy 2

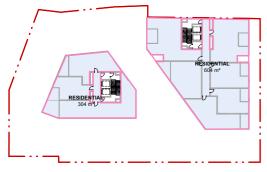


BASEMENT 3 LOWER GROUND GFA Copy 2

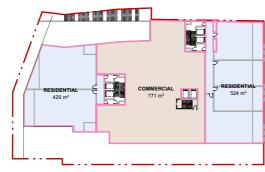


LEVEL 01 GFA Copy 2

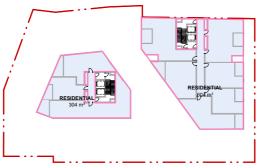


LEVEL 06 GFA Copy 2

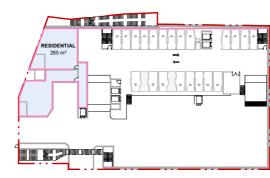

BASEMENT 03 GFA Copy 2

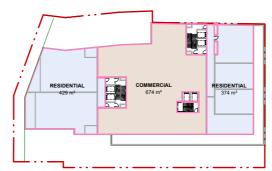


LEVEL 02 GFA Copy 2

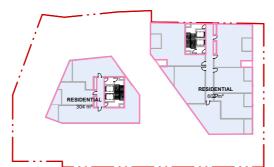


LEVEL 07 GFA Copy 2




BASEMENT 02 GFA Copy 2

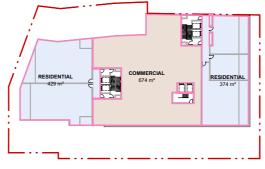




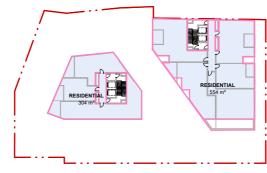


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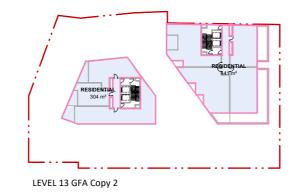
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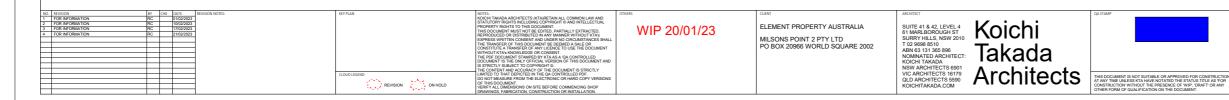


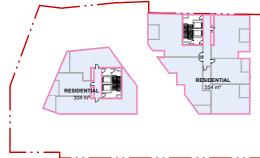
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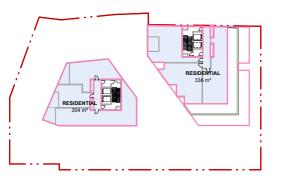


LEVEL 12 GFA Copy 2

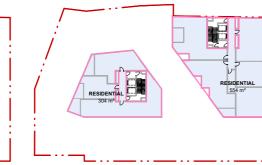



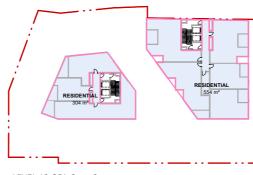

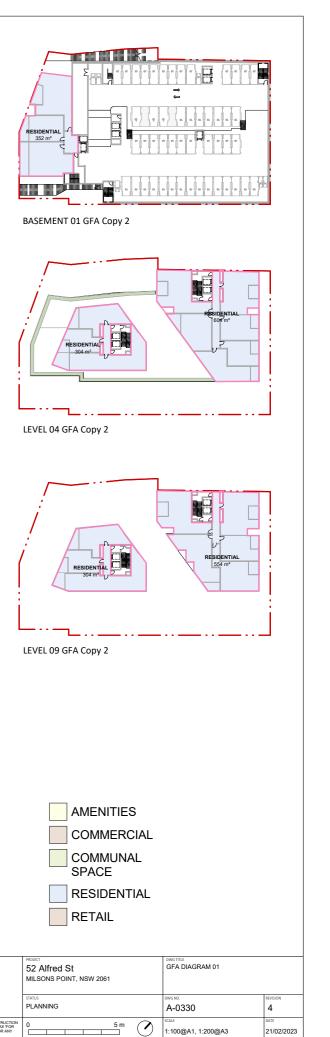

Area Schedule (GFA)

500 m<sup>2</sup> 500 m<sup>2</sup>

771 m<sup>2</sup>

674 m²

674 m<sup>2</sup> 2388 m<sup>2</sup>

265 m<sup>2</sup>

352 m²

352 m<sup>2</sup>

524 m<sup>2</sup>

429 m<sup>2</sup>

429 m<sup>2</sup>

374 m<sup>2</sup>

429 m<sup>2</sup>


374 m<sup>2</sup>


304 m<sup>2</sup>


604 m<sup>2</sup>

304 m<sup>2</sup>

Area

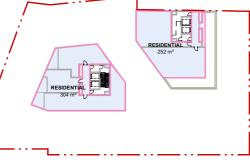

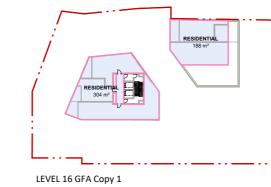

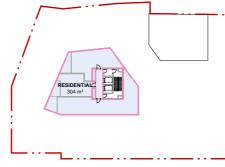

LEVEL 17 GFA Copy 1

LEVEL 14 GFA Copy 1

Level

BASEMENT 3 LOWER 269 m<sup>2</sup> GROUND

AMENITIES

COMMERCIAL

LEVEL 01

LEVEL 02

LEVEL 03

RESIDENTIAL BASEMENT 03

BASEMENT 02

BASEMENT 01

LEVEL 01

LEVEL 01

LEVEL 02

LEVEL 02

LEVEL 03

LEVEL 03

LEVEL 04

LEVEL 04

LEVEL 05

LEVEL 15 GFA Copy 1


I		
	Level	Area
	LEVEL 05	604 m <sup>2</sup>
	LEVEL 06	304 m <sup>2</sup>
	LEVEL 06	604 m <sup>2</sup>
	LEVEL 07	304 m <sup>2</sup>
	LEVEL 07	604 m²
	LEVEL 08	304 m <sup>2</sup>
	LEVEL 08	554 m²
	LEVEL 09	304 m <sup>2</sup>
	LEVEL 09	554 m²
	LEVEL 10	304 m <sup>2</sup>
	LEVEL 10	554 m²
	LEVEL 11	304 m <sup>2</sup>
	LEVEL 11	554 m²
	LEVEL 12	304 m <sup>2</sup>
	LEVEL 12	554 m²
	LEVEL 13	304 m <sup>2</sup>
	LEVEL 13	441 m <sup>2</sup>
	LEVEL 14	304 m <sup>2</sup>
	LEVEL 14	336 m <sup>2</sup>
	LEVEL 15	304 m <sup>2</sup>
	LEVEL 15	252 m²
	LEVEL 16	304 m <sup>2</sup>
	LEVEL 16	188 m²
	LEVEL 17	304 m <sup>2</sup>
		14188 m <sup>2</sup>
	RETAIL	
	UPPER GROUND	367 m <sup>2</sup>
	UPPER GROUND	166 m <sup>2</sup>
	UPPER GROUND	58 m²

Area Schedule (GFA)


	RETAIL	
	UPPER GROUND	367 m <sup>2</sup>
	UPPER GROUND	166 m <sup>2</sup>
	UPPER GROUND	58 m²
	UPPER GROUND	276 m <sup>2</sup>
-		867 m <sup>2</sup>
	Grand total	17944 m²

	NO. REVISION BY	BY CHK DATE REVISION NOTES:	KEY PLAN	NOTES:	OTHERS	CLIENT	ARCHITECT	QA STAMP
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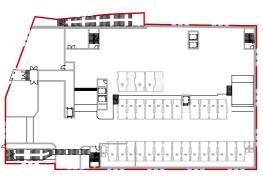
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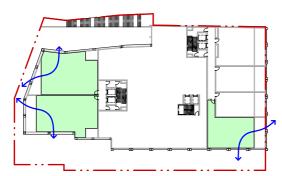
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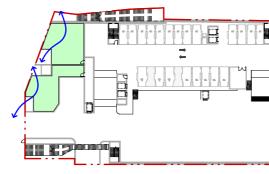
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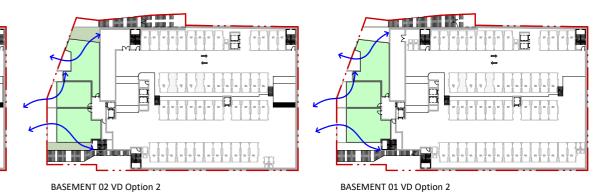
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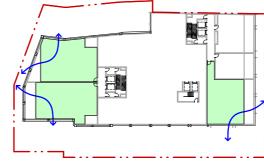
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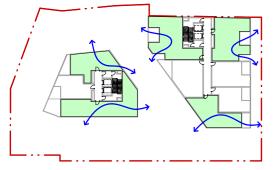
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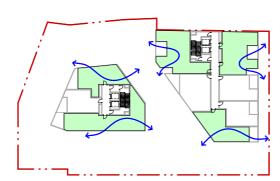


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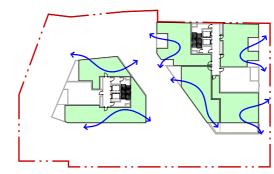
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LEVEL 06 VD Option 2

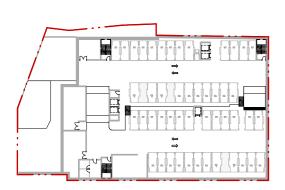

LEVEL 07 VD Option 2

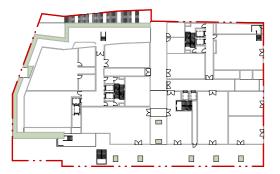
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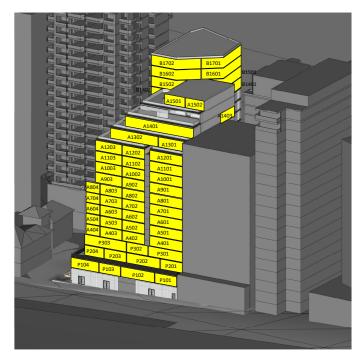
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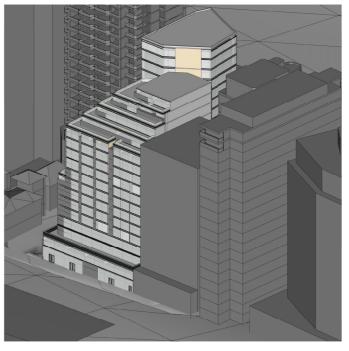


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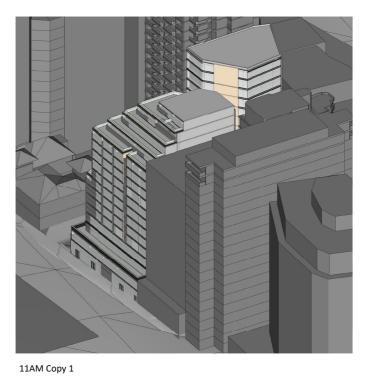
#### CROSS VENT COMPLIANCE

43 / 69 APARMENTS 62 %



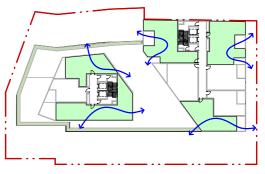


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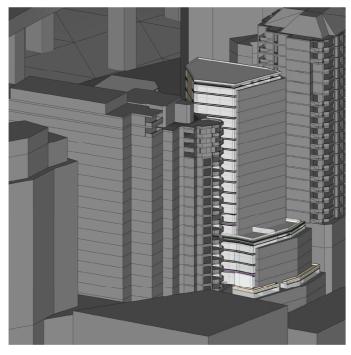


12PM Copy 1



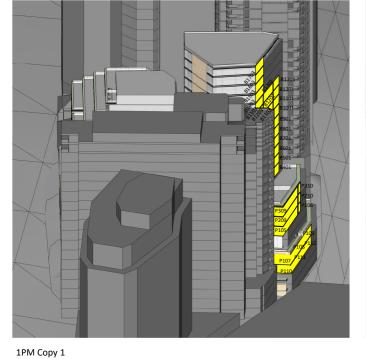

2PM Copy 1



3PM Copy 1





#### SOLAR COMPLIANCE

90 / 125 APARMENTS 72 %

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### **PLANNING PROPOSAL**

52 ALFRED STREET, MILSONS POINT

#### SEPP 65 CROSS VENTILATION

#### **CALCULATION METHOD**

Consistent with Steve King's Sepp 65 report which considers:

- All corner and 'through' apartments with openings in 2 principal facades as simply cross ventilated.
- The significant difference in level between the two street facades where a number of apartments within the lowest nine storeys as counted from the Alfred St facade, but which have increased exposure due to their greater height above Glen St are deemed cross ventilated in accordance with the ADG.

# ACHIEVED NATURAL VENTILATION ADG COMPLIANCE

There are 43 out of a total 125 apartments that are cross-ventilated within the scheme.

35 units are simply cross ventilated and another8 deemed ventilated in accrodance with the ADGDesign Criterion by virtue of their height above Glen St.

Overall, a total of 43 of the 69 apartments (62%) within the lowest nine storeys are cross ventilated.

This complies with the ADG Design Criterion requirement of a minimum 60% cross ventilated apartments in the first nine storeys of a building.

#### CALCULATION OF CROSS VENTILATION COMPLIANCE

GLEN ST LEVELS	ALFRED ST LEVELS	CROSS VENT	TOTAL UNITS
BASEMENT 4		0	0
BASEMENT 3		0	0
BASEMENT 3 Upper		2	2
BASEMENT 2		3	3
BASEMENT 1		3	3
GROUND	GROUND	0	0
LEVEL 1	LEVEL 1	3	6
LEVEL 2	LEVEL 2	3	6
LEVEL 3	LEVEL 3	3	5
LEVEL 4	LEVEL 4	5	9
	LEVEL 5	5	9
	LEVEL 6	5	9
	LEVEL 7	5	9
	LEVEL 8	6	8
		43	69
		COMPLIANT	62%
		TOTAL APT	43/125

34%

#### **ADG OBJECTIVE 4B-3**

#### Design criteria

- At least 60% of apartments are naturally cross ventilated in the first nine storeys of the building. Apartments at ten storeys or greater are deemed to be cross ventilated only if any enclosure of the balconies at these levels allows adequate natural ventilation and cannot be fully enclosed
- Overall depth of a cross-over or cross-through apartment does not exceed 18m, measured glass line to glass line

52 ALFRED STREET MILSONS POINT

#### 95

# Koichi Takada Architects

52 ALFRED STREET, MILSONS POINT

#### SEPP 65 SOLAR ACCESS

#### SOLAR ACCESS SUMMARY

Thorough analysis was undertaken through the use of a full 3D digital model in which adverse overshadowing from buildings adjacent to and remote from the site has been taken account of.

Out of 125 total apartments, 90 apartments (72%) achieves more than 2 hours of direct sunlight between 9am - 3pm (mid winter 21st June).

This complies with the ADG design criterion which requires at least 70% of apartments in a building to receive a minimum of 2 hours direct sunlight between 9am - 3pm at mid winter.

Considering that the subject site is disadvantaged by the adverse overshadowing from buildings adjacent to and remote from the site, the achievement of 70% solar access is a remarkably high level of compliance.

#### 52 ALFRED ST SOLAR ACCESS SUMMARY TABLE

9AM - 3PM		
TOTAL UNITS	125	
70%	87.5	
Units > 2hrs	90	
Units that receive		
no direct sunlight	20	
	16%	
Proposed	72%	

#### APARTMENT DESIGN GUIDE

#### Objective 4A-1

To optimise the number of apartments receiving sunlight to habitable rooms, primary windows and private open space

#### Design criteria

1.	Living rooms and private open spaces of at least 70%		
	of apartments in a building receive a minimum of 2		
	hours direct sunlight between 9 am and 3 pm at mid		
	winter in the Sydney Metropolitan Area and in the		
	Newcastle and Wollongong local government areas		

- In all other areas, living rooms and private open spaces of at least 70% of apartments in a building receive a minimum of 3 hours direct sunlight between 9 am and 3 pm at mid winter
- A maximum of 15% of apartments in a building receive no direct sunlight between 9 am and 3 pm at mid winter

52 ALFRED STREET MILSONS POINT

#### Design guidance

The design maximises north aspect and the number of single aspect south facing apartments is minimised

Single aspect, single storey apartments should have a northerly or easterly aspect

Living areas are best located to the north and service areas to the south and west of apartments

To optimise the direct sunlight to habitable rooms and balconies a number of the following design features are used:

- · dual aspect apartments
- · shallow apartment layouts
- · two storey and mezzanine level apartments
- · bay windows

To maximise the benefit to residents of direct sunlight within living rooms and private open spaces, a minimum of 1m<sup>2</sup> of direct sunlight, measured at 1m above floor level, is achieved for at least 15 minutes

Achieving the design criteria may not be possible on some sites. This includes:

- where greater residential amenity can be achieved along a busy road or rail line by orientating the living rooms away from the noise source
- · on south facing sloping sites
- where significant views are oriented away from the desired aspect for direct sunlight

Design drawings need to demonstrate how site constraints and orientation preclude meeting the design criteria and how the development meets the objective



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